



321 East Chapman Avenue
Fullerton, CA 92832


Heating Hot Water Replacement Parking Lot 10

DSA Back Check
January 8, 2020

MECHANICAL
P2S Inc.
Long Beach, CA 90815
562.497.2999




STRUCTURAL
MHP Structural Engineers
Long Beach, CA 90808
562.985.3200

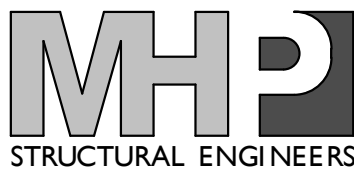

VICINITY MAP



SITE MAP

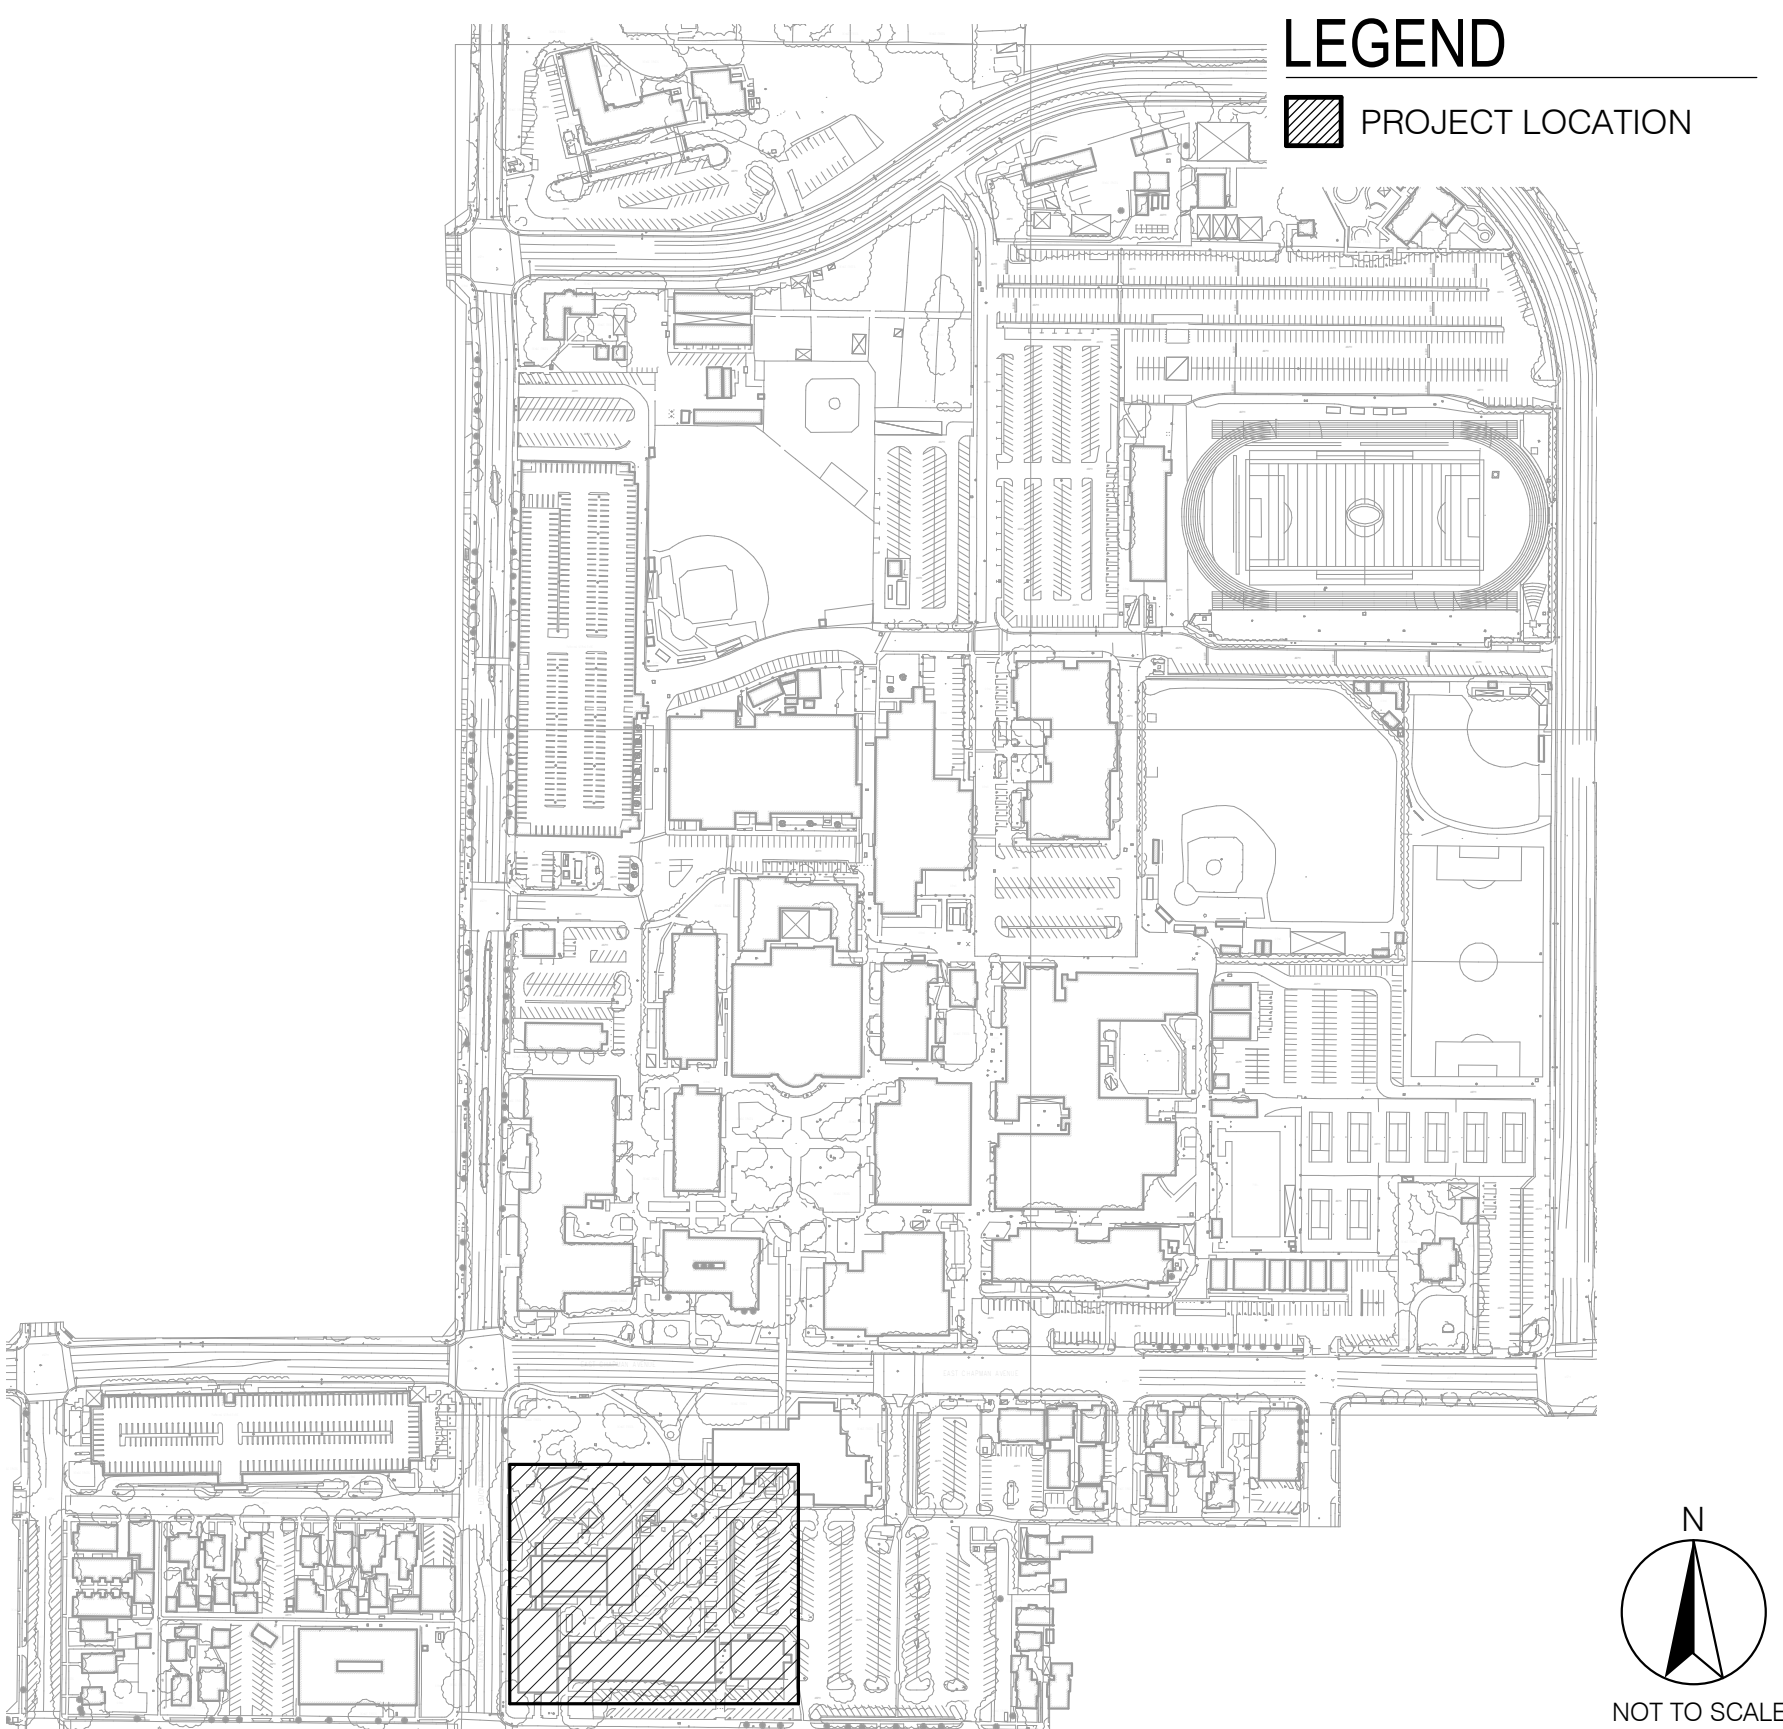

APPLICABLE CODES

LIST OF CALIFORNIA CODE OF REGULATIONS (C.C.R.):	
PART 1	2019 CALIFORNIA BUILDING STANDARDS ADMINISTRATIVE CODE, TITLE 24 C.C.R.
PART 2	2016 CALIFORNIA BUILDING CODE, TITLE 24 C.C.R. (2015 INTERNATIONAL BUILDING CODE VOL. 1-2 AND 2016 CALIFORNIA AMENDMENTS)
PART 2.5	2016 CALIFORNIA ELECTRICAL CODE, TITLE 24 C.C.R. (2015 NATIONAL ELECTRICAL CODE AND 2016 CALIFORNIA AMENDMENTS)
PART 4	2016 CALIFORNIA MECHANICAL CODE, TITLE 24 C.C.R. (2015 UNIFORM MECHANICAL CODE AND 2016 CALIFORNIA AMENDMENTS)
PART 5	2016 CALIFORNIA PLUMBING CODE, TITLE 24 C.C.R. (2015 UNIFORM PLUMBING CODE AND 2016 CALIFORNIA AMENDMENTS)
PART 6	2016 CALIFORNIA ENERGY CODE, TITLE 24 C.C.R.
PART 9	2016 CALIFORNIA FIRE CODE, TITLE 24 C.C.R.
PART 9	(2015 INTERNATIONAL FIRE CODE AND 2016 CALIFORNIA AMENDMENTS)
PART 11	2016 CALIFORNIA FIRE CODE, TITLE 24 C.C.R. - CHAPTER 33: FIRE SAFETY DURING CONSTRUCTION AND DEMOLITION.
PART 12	2016 CALIFORNIA GREEN BUILDING STANDARDS CODE (CALGREEN CODE), TITLE 24 C.C.R.
PART 12	2016 CALIFORNIA REFERENCED STANDARDS CODE, TITLE 24 C.C.R.
REFERENCED STANDARDS LISTED IN CHAPTER 35 CALIFORNIA BUILDING CODE 2016, VOLUME 2 REFERENCE STANDARDS CITED IN APPLICABLE PROVISIONS OF THE CBC SHALL APPLY TO THE EXTENT REFERENCED THEREIN AND ARE INCORPORATED IN THIS MANUAL AS IF SIMILARLY CITED. CALIFORNIA CODE OF REGULATIONS (C.C.R.), TITLE 9 INDUSTRIAL RELATIONS.	

PROJECT NOTES

ALL WORK SHALL CONFORM TO 2016 TITLE 24, CALIFORNIA CODE OF REGULATIONS (CCR).

CHANGES TO THE APPROVED DRAWINGS AND SPECIFICATIONS SHALL BE MADE BY AN ADDENDUM OR A CONSTRUCTION CHANGED DOCUMENT (CCD) APPROVED BY THE DIVISION OF THE STATE ARCHITECT, AS REQUIRED BY SECTION 4-338, PART 1, TITLE 24, CCR.

A 'DSA CERTIFIED' PROJECT INSPECTOR EMPLOYED BY THE DISTRICT (OWNER) AND APPROVED BY THE DSA SHALL PROVIDE CONTINUOUS INSPECTION OF THE WORK. THE DUTIES OF THE INSPECTOR ARE DEFINED IN SECTION 4-342, PART 1, TITLE 24, CCR.

A DSA ACCEPTED TESTING LABORATORY DIRECTLY EMPLOYED BY THE DISTRICT (OWNER) SHALL CONDUCT ALL THE REQUIRED TESTS AND INSPECTIONS FOR THE PROJECT.

THE INTENT OF THESE DRAWINGS AND SPECIFICATIONS IS THAT THE WORK OF THE ALTERATION, REHABILITATION, OR RECONSTRUCTION IS TO BE IN ACCORDANCE WITH THE TITLE 24, CCR. SHOULD ANY EXISTING CONDITIONS SUCH AS DETERIORATION OR NON-COMPLYING CONSTRUCTION BE DISCOVERED WHICH IS NOT COVERED BY THE CONTRACT DOCUMENTS WHEREIN THE FINISHED WORK WILL NOT COMPLY WITH TITLE 24, CCR, A CONSTRUCTION CHANGE DOCUMENT (CCD), OR A SEPARATE SET OF PLANS AND SPECIFICATIONS, DETAILED AND SPECIFYING THE REQUIRED WORK SHALL BE SUBMITTED TO AND APPROVED BY DSA BEFORE PROCEEDING WITH THE WORK. (SECTION 4-317(c), PART 1, TITLE 24 CCR)

GRADING PLANS, DRAINAGE IMPROVEMENTS, ROAD AND ACCESS REQUIREMENTS, AND ENVIRONMENTAL HEALTH CONSIDERATIONS SHALL COMPLY WITH ALL LOCAL ORDINANCES.



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TOTAL: 28			

SCOPE OF WORK

THIS PROJECT WILL REPLACE AND REROUTE CAMPUS HEATING HOT WATER DISTRIBUTION PIPES TO REMEDY EXISTING UNDERGROUND LEAKAGE CONCERNS. SCOPE OF WORK INCLUDES: UNDERGROUND PIPING FROM BUILDING 2100 TO BUILDING 2001/2000; REPLACEMENT ROOF MOUNTED PIPING ON BUILDING 2100; ADDITIONAL ROOF MOUNTED PIPING ON BUILDING 2100; BUILDING 100; BUILDING 200; AND BUILDING 300; AND REPLACEMENT CEILING HUNG PIPING IN BUILDING 2100 BASEMENT. A UTILITY SEARCH TO IDENTIFY EXISTING OBSTRUCTIONS SHALL BE PERFORMED PRIOR TO BEGINNING DEMOLITION. THE HHW SYSTEM CHANGEOVER SHALL OCCUR WITHOUT DISRUPTING THE HOT WATER DISTRIBUTION DURING THE CAMPUS' OPERATING HOURS.

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IDENTIFICATION STAMP
DIV. OF THE STATE ARCHITECT
APP. 04-118731 INC.
REVIEWED FOR
SS ☒ FLS ☒ ACS ☒
DATE: 01.09.20

P2S ENG

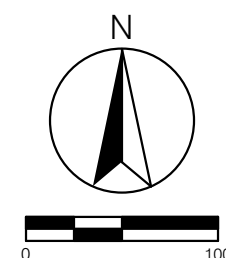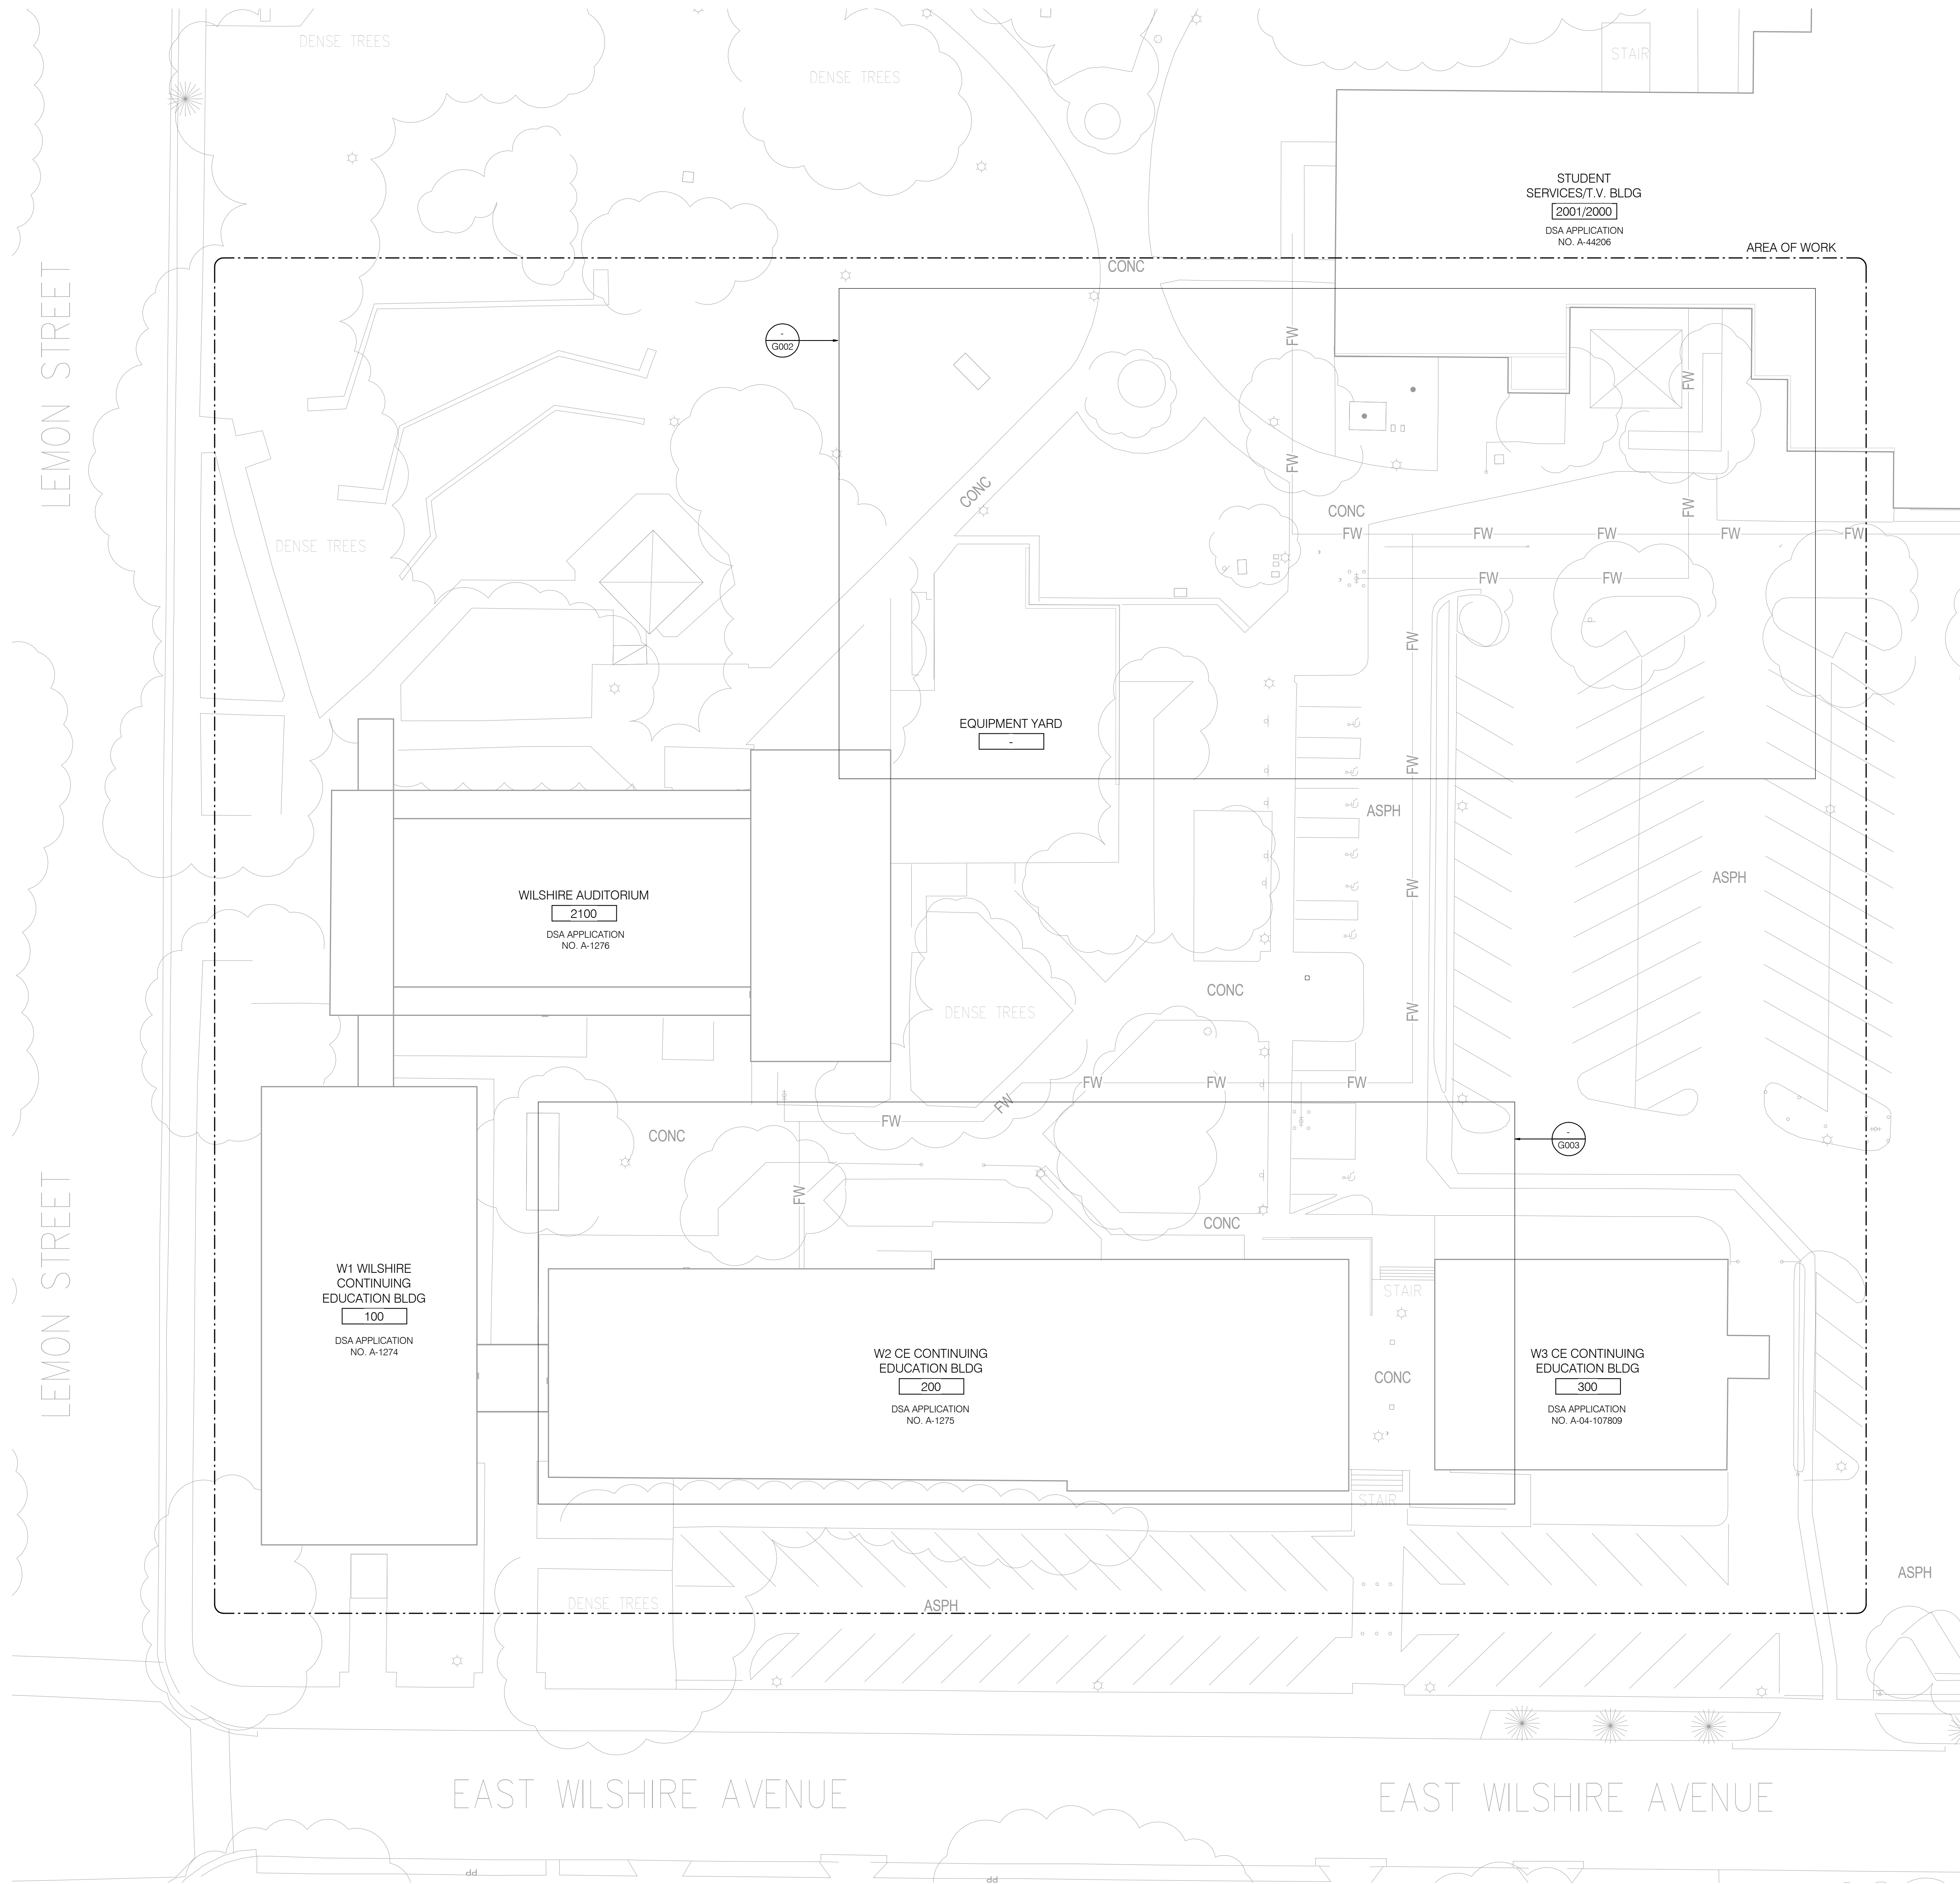Long Beach | Los Angeles
San Diego | San Jose

p2sinc.com

Consultant

Project Title

Heating Hot Water
Replacement Parking Lot 10

Owner



321 East Chapman Avenue
Fullerton, CA 92832



Revisions

Number	Description	Date
1	DSA Submittal	10/29/2019
2	DSA Back Check	1/8/2020

Designed T Mueller
Drawn T Mueller
Checked C Dean
Approved M Phillips

Date January 8, 2020

Submittal DSA Back Check

Scale 1" = 20'

Sheet Title


Area of Work Map

Sheet Number

G001

P2S No. 9570

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GENERAL NOTES

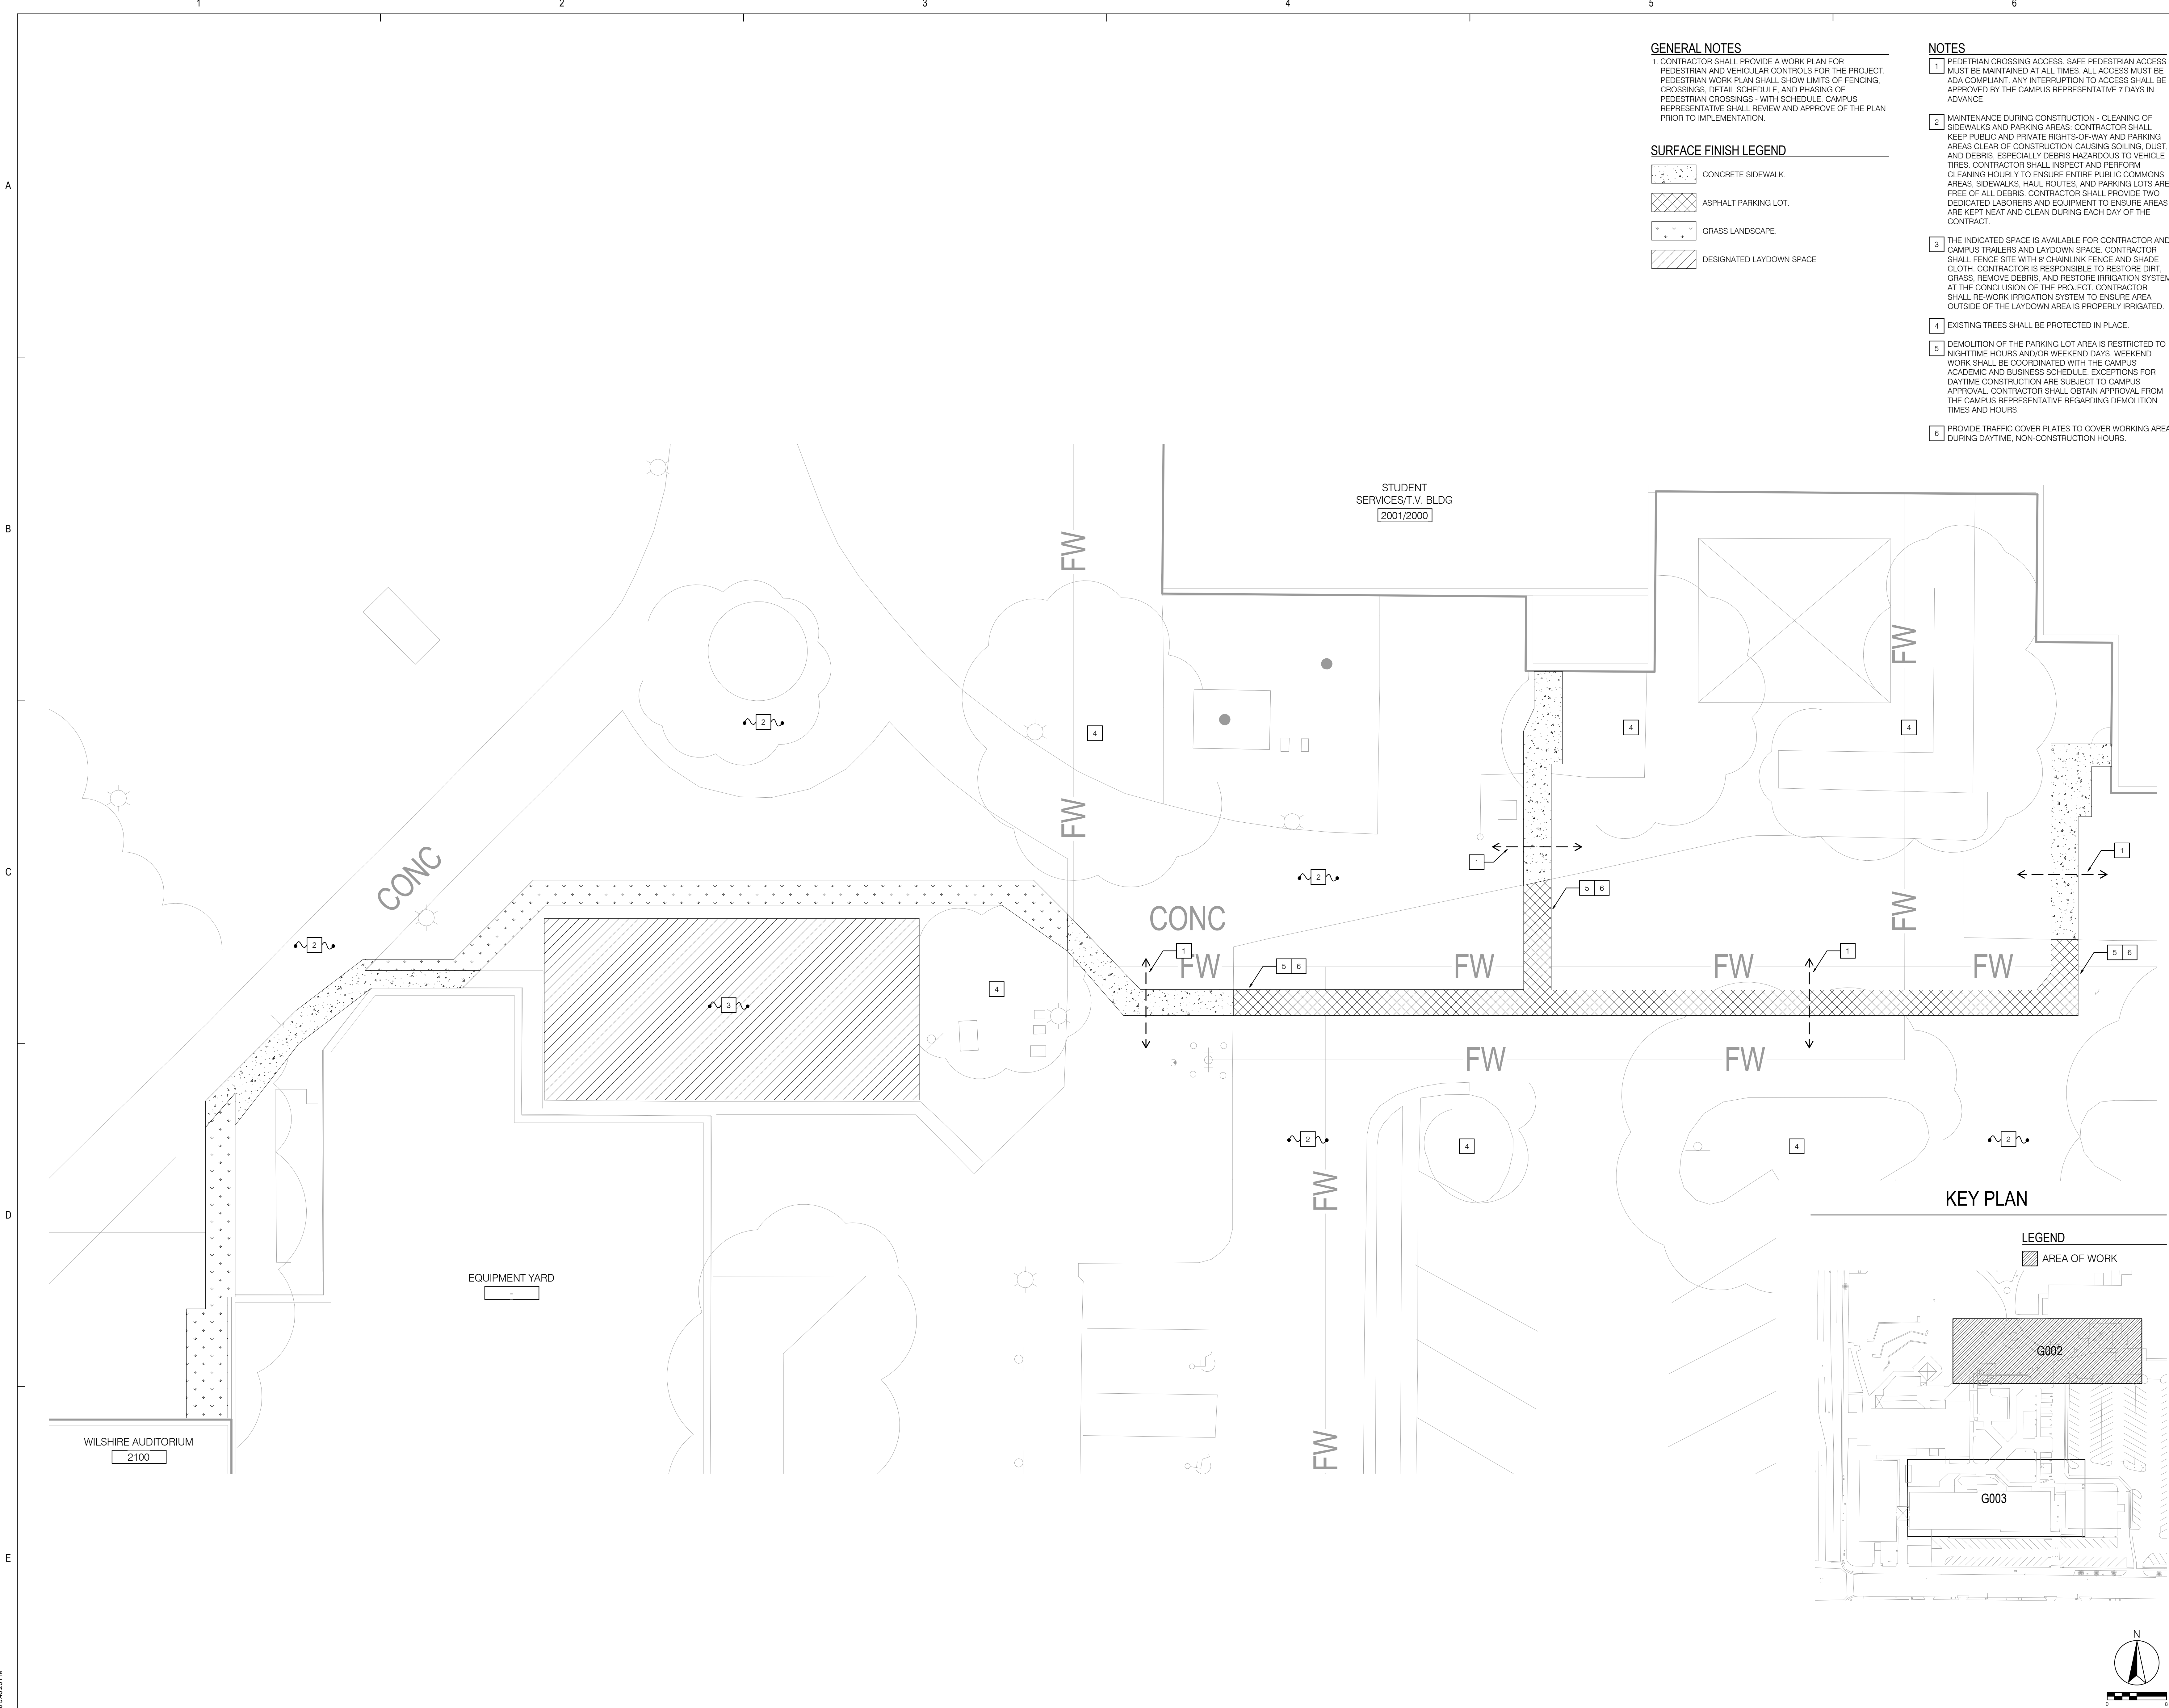1. CONTRACTOR SHALL PROVIDE A WORK PLAN FOR PEDESTRIAN AND VEHICULAR CONTROLS FOR THE PROJECT. PEDESTRIAN WORK PLAN SHALL SHOW LIMITS OF FENCING, CROSSINGS, DETAIL SCHEDULE, AND PHASING OF PEDESTRIAN CROSSINGS - WITH SCHEDULE. CAMPUS REPRESENTATIVE SHALL REVIEW AND APPROVE OF THE PLAN PRIOR TO IMPLEMENTATION.

SURFACE FINISH LEGEND

- CONCRETE SIDEWALK.
- ASPHALT PARKING LOT.
- GRASS LANDSCAPE.
- DESIGNATED LAYDOWN SPACE


NOTES

- PEDESTRIAN CROSSING ACCESS. SAFE PEDESTRIAN ACCESS MUST BE MAINTAINED AT ALL TIMES. ALL ACCESS MUST BE ADA COMPLIANT. ANY INTERRUPTION TO ACCESS SHALL BE APPROVED BY THE CAMPUS REPRESENTATIVE 7 DAYS IN ADVANCE.
- MAINTENANCE DURING CONSTRUCTION - CLEANING OF SIDEWALKS AND PARKING AREAS. CONTRACTOR SHALL KEEP PUBLIC AND PRIVATE RIGHTS-OF-WAY AND PARKING AREAS CLEAR OF CONSTRUCTION-CAUSING SOILING, DUST, AND DEBRIS. ESPECIALLY DEBRIS HAZARDOUS TO VEHICLE TIRES. CONTRACTOR SHALL INSPECT AND PERFORM CLEANING HOURLY TO ENSURE ENTIRE PUBLIC COMMONS AREAS, SIDEWALKS, TRAIL ROUTES, AND PARKING LOTS ARE FREE OF ALL DEBRIS. CONTRACTOR SHALL PROVIDE TWO DEDICATED LABORERS AND EQUIPMENT TO ENSURE AREAS ARE KEPT NEAT AND CLEAN DURING EACH DAY OF THE CONTRACT.
- THE INDICATED SPACE IS AVAILABLE FOR CONTRACTOR AND CAMPUS TRAILERS AND LAYDOWN SPACE. CONTRACTOR SHALL FENCE SITE WITH 6' CHAINLINK FENCE AND SHADE CLOTH. CONTRACTOR IS RESPONSIBLE TO RESTORE DIRT GRASS, REMOVE DEBRIS, AND RESTORE IRRIGATION SYSTEM AT THE CONCLUSION OF THE PROJECT. CONTRACTOR SHALL RE-WORK IRRIGATION SYSTEM TO ENSURE AREA OUTSIDE OF THE LAYDOWN AREA IS PROPERLY IRRIGATED.
- EXISTING TREES SHALL BE PROTECTED IN PLACE.
- DEMOLITION OF THE PARKING LOT AREA IS RESTRICTED TO NIGHTTIME HOURS AND/OR WEEKEND DAYS. WEEKEND WORK SHALL BE COORDINATED WITH THE CAMPUS ACADEMIC AND BUSINESS SCHEDULE. EXCEPTIONS FOR DAYTIME CONSTRUCTION ARE SUBJECT TO CAMPUS APPROVAL. CONTRACTOR SHALL OBTAIN APPROVAL FROM THE CAMPUS REPRESENTATIVE REGARDING DEMOLITION TIMES AND HOURS.
- PROVIDE TRAFFIC COVER PLATES TO COVER WORKING AREA DURING DAYTIME, NON-CONSTRUCTION HOURS.

KEY PLAN

LEGEND

- AREA OF WORK

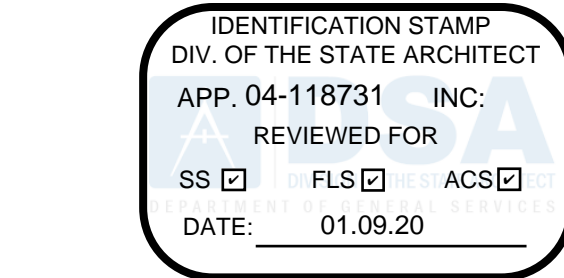

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	DSA Back Check	1/8/2020

Designed	T Mueller
Drawn	T Mueller
Checked	C Dean
Approved	M Phillips

Date January 8, 2020

Submittal DSA Back Check

Scale 1/8" = 1'-0"

Sheet Title
**Pedestrian Access Map
North**

Sheet Number

G002

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A

B

C

D

E



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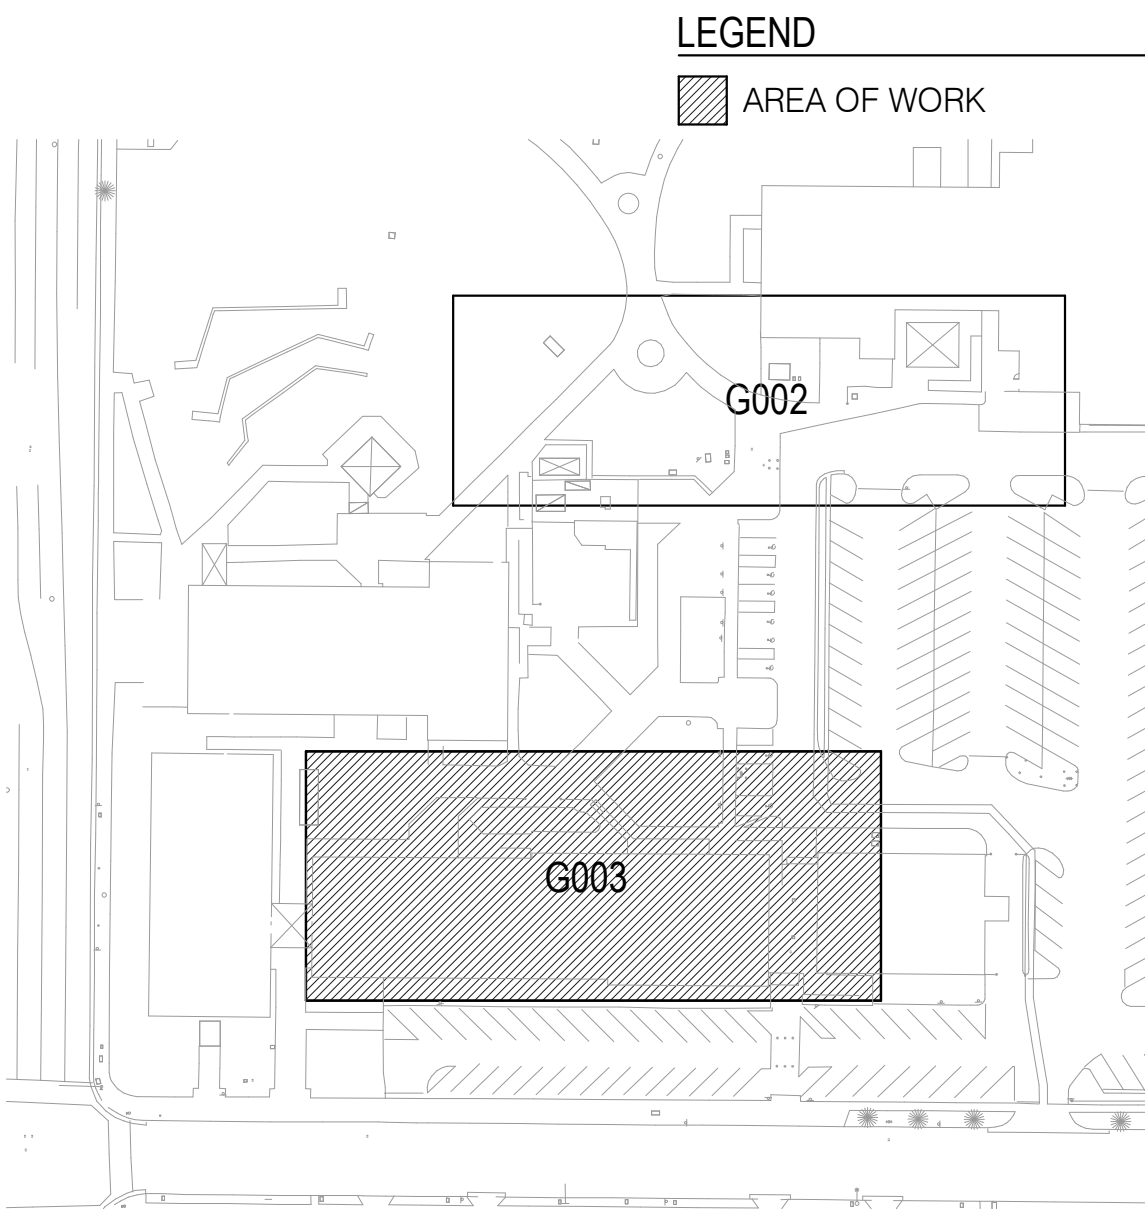
SURFACE FINISH LEGEND

- CONCRETE SIDEWALK.
- PLANT LANDSCAPE.

NOTES


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KEY PLAN



LEGEND

- AREA OF WORK

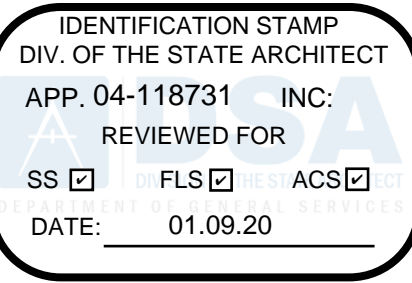

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Checked	C Dean
Approved	M Phillips

Date January 8, 2020

Submittal DSA Back Check

Scale 1/8" = 1'-0"

Sheet Title
**Pedestrian Access Map
South**

Sheet Number

G003

P2S No. 9570



321 East Chapman Avenue
Fullerton, CA 92832



Revisions

Number	Description	Date
	DSA Submittal	10/29/2019
	DSA Back Check	1/8/2020

[illegible]

Designed	T Mueller
Drawn	T Mueller
Checked	C Dean
Approved	M Phillips

Date January 8, 2020

Submittal	DSA Back Check
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Scale	No Scale
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Sheet Title


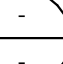








General Notes, Legend,
Abbreviations and Sheet
Index

Sheet Number

M001

P2S No. 9570

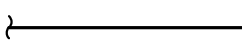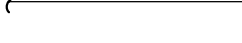GENERAL LEGEND

SYMBOL	DESCRIPTION
	NOTE CALLOUT
	DETAIL CALLOUT - NUMBER ON TOP DENOTES DETAIL NUMBER - NUMBER ON BOTTOM DENOTES SHEET DETAIL, IS SHOWN
	MECHANICAL EQUIPMENT CALLOUT. SEE MECHANICAL PLANS FOR EXACT LOCATION AND REQUIREMENTS
	SECTION CALLOUT
	POINT OF CONNECTION
	POINT OF DISCONNECTION
	NEW LINEWORK
	EXISTING LINEWORK
	DEMOLITION LINEWORK
	DIRECTION OF FLOW

PIPING LEGEND

SYMBOL	DESCRIPTION
	NEW PIPING (SIZE-SERVICE)
	EXISTING PIPING (SIZE-SERVICE)
	ELBOW FACING AWAY FROM VIEWER
	ELBOW FACING TOWARD VIEWER
	TEE FACING AWAY FROM VIEWER
	TEE FACING TOWARD VIEWER
	PIPE CAP
	TRANSITION, ASYMMETRIC
	TRANSITION, SYMMETRIC
	EXPANSION JOINT (COMPENSATOR)
	PIPE GUIDE
	PIPE ANCHOR
	UNION, SCREWED
	BALL VALVE
	BALL VALVE W/ ACTUATOR
	BUTTERFLY VALVE
	BUTTERFLY VALVE W/ ACTUATOR
	GATE VALVE
	GATE VALVE W/ ACTUATOR
	GLOBE VALVE
	GLOBE VALVE W/ ACTUATOR
	THREE-WAY VALVE
	AIR SEPARATOR

ABBREVIATIONS

ABBREVIATION	DESCRIPTION	ABBREVIATION	DESCRIPTION
(E)	EXISTING	HT	HEIGHT
AAV	AUTOMATIC AIR VENT	HZ	HERTZ
AFV	ABOVE FINISHED FLOOR	ID	INSIDE DIAMETER
AHU	AIR HANDLING UNIT	IN	INCHES
AP	ACCESS PANEL	KW	KILOWATTS
APD	AIR PRESSURE DROP	LAT	LEAVING AIR TEMPERATURE
BO	BLOWDOWN	LBS	POUNDS
BOB	BACK DRAFT DAMPER	LF	LINEAR FEET
BPC	BELOW FINISHED CEILING	LEW	LEAVING WATER TEMPERATURE
BFP	BACK FLOW PREVENTER	LMT	MAXIMUM
BHP	BREAK HORSEPOWER	MBH	THOUSAND BTU PER HOUR
BLDG	BUILDING	M	MECHANICAL CONTRACTOR
BOB	BOTTOM OF BEAM	MCA	MINIMUM CIRCUIT AMPS
BOF	BOTTOM OF PIPE	MH	MANHOLE
BTU	BRITISH THERMAL UNIT	MIN	MINIMUM
CFM	CUBIC FEET PER MINUTE	MOC	MAXIMUM OVERLOAD CIRCUIT PROTECTION
CHWR	CHILLED WATER RETURN	NFA	NET FREE AREA
CHWS	CHILLED WATER SUPPLY	NC	NOT IN CONTRACT
CI	CAST IRON	NPSHR	NET POSITIVE SUCTION HEAD REQUIRED
CL	CENTER LINE	OA	OUTSIDE AIR
CP	CONDENSATE PUMP	OAT	OUTSIDE AIR TEMPERATURE
CT	COOLING TOWER	OBD	OPPOSED BLADE DAMPER
CU	CONDENSING UNIT	OC	ON CENTER
CV	CONSTANT VOLUME BOX	OD	OUTSIDE DIAMETER
CWFR	CONDENSER WATER FILTER RETURN	PD	PRESSURE DROP
CWFS	CONDENSER WATER FILTER SUPPLY	PERF	PERFORATED
CWR	CONDENSER WATER RETURN	PH	PHASE
CWS	CONDENSER WATER SUPPLY	PP	POINT OF DISCONNECT
DB	DRY BULB	PR	PRESSURE RELIEF
DEG	DEGREES	PRV	PRESSURE REDUCING VALVE
DIA	DIAMETER	PSID	POUNDS PER SQUARE INCH DIFFERENTIAL
DL	DOOR LOUVER	PSIG	POUNDS PER SQUARE INCH GAUGE
DN	DOWN	PVC	POLYVINYL CHLORIDE
DX	DIRECT EXPANSION	RA	RETURN AIR
EA	EACH	RAU	RETURN AIR UNIT
EAT	ENTERING AIR TEMPERATURE	RL	RATED LOAD AMPS
EC	ELECTRICAL CONTRACTOR	RPM	REVOLUTIONS PER MINUTE
EFF	EFFICIENCY	SA	SUPPLY AIR
EL	ELEVATION	SF	SUPPLY FAN
ESP	EXTERNAL STATIC PRESSURE	SPEC	SPECIFICATION
EWT	ENTERING WATER TEMPERATURE	SS	STAINLESS STEEL
FG	FIRE DAMPER	STD	STANDARD
FLA	FULL LOAD AMPS	TAD	TRANSFER AIR DUCT
FLR	FLOOR	TDH	TOTAL DYNAMIC HEAD
F08	FLAT ON BOTTOM	TG	TOTAL ENCLOSED FAN COOLED
FOT	FLAT ON TOP	TSP	TOTAL STATIC PRESSURE
FPI	FPS PER INCH	TYP	TYPICAL
FFM	FEET PER MINUTE	UC	UNDERCUT
FSD	FIRE SMOKE DAMPER	V	VOLTS
FT	FEET PER FOOT	VAV	VARIABLE AIR VOLUME
FX	FLEXIBLE CONNECTION	VD	VOLTS DAMPER
GA	GAUGE	VFD	VARIABLE FREQUENCY DRIVE
GALV	GALVANIZED	VTR	VENT THRU ROOF
GC	GENERAL CONTRACTOR	W	WITH
GPM	GALLONS PER HOUR	WO	WITHOUT
GPM	GALLONS PER MINUTE	WB	WET BULB
HB	HOSE BIBB	WC	WATER COLUMN
HD	HEAD	WG	WATER GAUGE
HHWR	HEATING HOT WATER RETURN	WPD	WATER PRESSURE DROP
HHWS	HEATING HOT WATER SUPPLY	W	WEIGHT
HP	HEAT PUMP	°F	DEGREES FAHRENHEIT
HP	HORSEPOWER		

IN THE EVENT ABBREVIATIONS NOT MENTIONED HEREIN ARE USED, REFERENCE WILL BE MADE TO ANSI Y1.1, MILITARY STANDARD ABBREVIATIONS AND OTHER STANDARD INDUSTRY CONVENTIONS.

CONTROL ABBREVIATIONS

ABBREVIATION	DESCRIPTION	ABBREVIATION	DESCRIPTION
A	ALARM	PS	PRESSURE SWITCH
AFMS	AIRFLOW MONITORING STATIONS	PT	PRESSURE TRANSMITTER
AI	ANALOG INPUT	PH	RELATIVE HUMIDITY
AO	ANALOG OUTPUT	S	STATUS
CS	CURRENT SWITCH	SC	SPEED CONTROL
DI	DIGITAL INPUT	SI	SPEED INDICATOR
DO	DIGITAL OUTPUT	SP	SETPOINT
DP	DIFFERENTIAL PRESSURE	SS	START/STOP
FM	FLOW METER	T	TEMPERATURE
FS	FLOW SWITCH	TI	TEMPERATURE INDICATOR
HQA	HANDS-OFF-AUTO	VA	DAMPER/VALVE ACTUATOR
KW	KILOWATTS	VP	VELOCITY PRESSURE
LA	LEVEL ALARM	VSH	VIBRATION SWITCH
MOD	MOTOR OPERATED DAMPER	ZC	CLOSED END SWITCH
NC	NORMALLY CLOSED	ZI	POSITION INDICATOR
NO	NORMALLY OPEN	ZO	OPEN END SWITCH

IN THE EVENT ABBREVIATIONS NOT MENTIONED HEREIN ARE USED, REFERENCE WILL BE MADE TO ANSI Y1.1, MILITARY STANDARD ABBREVIATIONS AND OTHER STANDARD INDUSTRY CONVENTIONS.

SHEET INDEX

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M602	DETAILS
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M20204	ENLARGED SITE PLAN DEMOLITION
M20205	BUILDING 2100 - BASEMENT DEMOLITION
M20211	DEMOLITION PLAN BUILDING 2100
M20212	DEMOLITION PLAN BUILDING 2001/2000

GENERAL NOTES

1. ALL WORK SHALL COME WITH THE 2016 EDITIONS OF THE CALIFORNIA BUILDING, MECHANICAL PLUMBING, AND OTHER APPLICABLE FEDERAL, STATE, OR LOCAL CODES AS ADOPTED AND ENFORCED BY THE LOCAL JURISDICTION. IN CASE THE PLANS SHOW MORE STRINGENT REQUIREMENTS, THE PLANS SHALL MAINTAIN THE DESIGN, YET WITHIN ON THE DESIGN DOCUMENTS SHALL BE INTERPRETED AS AUTHORITY TO VIOLATE CODE(S) OR REGULATION(S).
2. SUBMISSION OF BID IN CONNECTION WITH THIS WORK SHALL IMPLY THAT THE BIDDER HAS EXAMINED THE JOB SITE UNDER WHICH THE CONTRACTOR WILL BE OBLIGATED TO OPERATE UNDER THIS CONTRACT. NO EXTRA CHARGE WILL BE ALLOWED FOR FAILURE OF ANY BIDDER TO EXAMINE THE SITE PRIOR TO BID.
3. WHERE USED, THE TERM 'PROVIDE' SHALL MEAN 'FURNISH AND INSTALL'.
4. IN THE EVENT OF A CONFLICT OR INCONSISTENCY BETWEEN ITEMS INDICATED ON DRAWINGS AND SPECIFICATIONS WITH CODE REQUIREMENTS, THE MORE STRINGENT STANDARD SHALL PREVAIL.
5. CARE SHALL BE EXERCISED TO MINIMIZE ANY INCONVENIENCE OR DISTURBANCE TO OTHER AREAS OF THE BUILDING WHICH ARE TO REMAIN IN OPERATION. ISOLATE WORK AREAS TO KEEP DUST AND DIRT OUT OF THE CONSTRUCTION AREA.
6. NO PIPING, EQUIPMENT, ETC. SHALL BE REMOVED, DISCONNECTED OR SHUT DOWN WITHOUT PRIOR NOTICE TO THE OWNER. THE OWNER WILL CONFIRM THAT AREAS TO REMAIN IN OPERATION WILL NOT BE AFFECTED. IF ANY AREAS NOT WITHIN THE SCOPE OF WORK ARE AFFECTED BY ANY SHUTDOWN, REMOVAL OR DISCONNECTION, SUFFICIENT ADVANCE NOTICE MUST BE GIVEN TO THE OWNER INDICATING WHICH AREAS WILL BE AFFECTED, WHEN THE PROPOSED SHUTDOWN WILL OCCUR, AND FOR HOW LONG A PERIOD OF TIME.
7. THE ARRANGEMENT OF EQUIPMENT AND PIPING SHOWN ON THE DRAWINGS IS BASED UPON INFORMATION AVAILABLE TO THE ENGINEER AT THE TIME OF DESIGN AND IS NOT INTENDED TO SHOW EXACT DIMENSIONS. THIS CONTRACTOR SHALL VERIFY ALL DIMENSIONS AT THE SITE MAKING FIELD MEASUREMENTS AND SHOP DRAWINGS NECESSARY FOR FABRICATION OR ERECTION OF HVAC SYSTEMS, MECHANICAL SPACE FOR BEAMS, PIPES AND CONNECTIONS IN BUILDING CONSTRUCTION. CHECK DRAWINGS SHOWING WORK OF OTHER TRADES AND CONSULT WITH THE OWNER'S REPRESENTATIVE IN THE EVENT OF POTENTIAL INTERFERENCE. SHOP DRAWINGS SHALL BE MINIMUM 1/4" = 1' SCALE, INDICATING FITTINGS, SIZES, WELDS AND CONFIGURATIONS AND SUBMITTED TO ENGINEER FOR REVIEW.
8. THIS CONTRACTOR SHALL COORDINATE HIS WORK WITH ALL OTHER TRADES PRIOR TO FABRICATION, PURCHASE AND/OR INSTALLATION OF ALL WORK.
9. EXISTING MATERIALS THAT ARE REMOVED SHALL NOT BE REUSED IN NEW SYSTEMS, EXCEPT WHERE INDICATED AS BEING REINSTALLED.
10. ALL EQUIPMENT SHALL BE REINSTALLED IN STRICT COMPLIANCE WITH THE MANUFACTURER'S WRITTEN INSTRUCTIONS.
11. THIS CONTRACTOR SHALL NOT BORE, NOTCH, CUT, OR PENETRATE INTO A STRUCTURAL MEMBER WITHOUT WRITTEN APPROVAL FROM A DESIGNATED STRUCTURAL ENGINEER AND THE OWNER.
12. ALL PIPE ELBOWS SHALL BE LONG RADIUS UNLESS OTHERWISE SPECIFICALLY NOTED ON THE DRAWINGS.
13. INSTALL MAINLINE VOLUME DAMPERS WITHIN DUCT BRANCHES TO BALANCE AIRFLOW CFM. ON INSULATED DUCTS, MOUNT DAMPER REGULATOR ON 2" STAND-OFF BRACKET TO CLEAR INSULATION.
14. ALL MATERIAL EXPOSED WITHIN RA PLenums SHALL BE NON-COMBUSTIBLE OR SHALL HAVE A FLAME SPREAD INDEX NOT GREATER THAN 25 AND SMOKE DEVELOPED INDEX NOT GREATER THAN 50. COMPLY WITH CM2-602.2.
15. COORDINATE ACCESS TO EQUIPMENT WITH WORK OF OTHER TRADES. PROVIDE DUCT ACCESS DOORS, HANGING ACCESS DOORS, YET WITHIN ON THE DESIGN DOCUMENTS SHALL BE INTERPRETED AS AUTHORITY TO VIOLATE CODE(S) OR REGULATION(S).
16. MECHANICAL COMPONENT ANCHORAGE NOTES:

ALL MECHANICAL COMPONENTS SHALL BE ANCHORED AND INSTALLED PER THE DETAILS ON THE DSA APPROVED CONSTRUCTION DOCUMENTS. WHERE NO DETAIL IS INDICATED, THE FOLLOWING COMPONENTS SHALL BE ANCHORED OR BRACED TO MEET THE FORCE AND DISPLACEMENT REQUIREMENTS PRESCRIBED IN THE 2016 CBC, SECTIONS 1616A.1.18 THROUGH 1616A.1.26 AND ASCE 7-10 CHAPTER 13, 26 AND 30.

1. ALL PERMANENT EQUIPMENT AND COMPONENTS.
2. TEMPORARY OR MOVABLE EQUIPMENT THAT IS PERMANENTLY ATTACHED (E.G. HARD WIRED) TO THE BUILDING UTILITY SERVICES SUCH AS ELECTRICITY, GAS OR WATER.
3. MOVABLE EQUIPMENT WHICH IS STATIONED IN ONE PLACE FOR MORE THAN 8 HOURS AND HEAVIER THAN 400 POUNDS ARE REQUIRED TO BE ANCHORED WITH TEMPORARY ATTACHMENTS.

THE FOLLOWING MECHANICAL COMPONENTS SHALL BE POSITIVELY ATTACHED TO THE STRUCTURE, BUT NEED NOT BE DETAILED ON THE PLANS. THESE COMPONENTS SHALL HAVE FLEXIBLE CONNECTIONS PROVIDED BETWEEN THE COMPONENT AND ASSOCIATED DUCTWORK, PIPING, AND CONDUIT:

- A. COMPONENTS WEIGHING LESS THAN 400 POUNDS AND HAVE A CENTER OF MASS LOCATED 4 FEET OR LESS ABOVE THE ADJACENT FLOOR OR ROOF LEVEL THAT DIRECTLY SUPPORT THE COMPONENT.
- B. COMPONENTS WEIGHING LESS THAN 20 POUNDS, OR IN THE CASE OF DISTRIBUTED SYSTEMS, LESS THAN 5 POUNDS PER FOOT, WHICH ARE SUSPENDED FROM A ROOF OR FLOOR OR HUNG

FOR THOSE ELEMENTS THAT DO NOT REQUIRE DETAILS ON THE APPROVED DRAWINGS, THE INSTALLATION SHALL BE SUBJECT TO THE APPROVAL OF THE DESIGN PROFESSIONAL IN GENERAL RESPONSIBLE CHARGE OR THE STRUCTURAL ENGINEER DELEGATED RESPONSIBILITY AND THE DSA DISTRICT STRUCTURAL ENGINEER. THE PROJECT INSPECTOR WILL VERIFY THAT ALL COMPONENTS AND EQUIPMENT HAVE BEEN ANCHORED IN ACCORDANCE WITH ABOVE REQUIREMENTS.

17. PIPING AND DUCTWORK DISTRIBUTION SYSTEM BRACING NOTE:

PIPING AND DUCTWORK DISTRIBUTION SYSTEMS SHALL BE BRACED TO COMPLY WITH THE FORCES AND DISPLACEMENTS PRESCRIBED IN ASCE 7-10 SECTION 13.3 AS DEFINED IN ASCE 7-10 SECTION 13.6.8, 13.6.7, 13.6.5.6, AND 2016 CBC SECTIONS 1616A.1.23, 1616A.1.24, 1616A.1.25 AND 1616A.1.26.


THE METHOD OF SHOWING BRACING AND ATTACHMENTS TO THE STRUCTURE FOR THE PIPING DISTRIBUTION SYSTEM ARE DETAILED ON THE APPROVED DRAWINGS WITH PROJECT SPECIFIC NOTES AND DETAILS. WHEN BRACING AND ATTACHMENTS ARE BASED ON A PREAPPROVED INSTALLATION GUIDE (E.G., SMACNA OR OSHPD OPM), COPIES OF THE BRACING SYSTEM INSTALLATION GUIDE OR MANUAL SHALL BE AVAILABLE ON THE JOBSITE PRIOR TO THE START OF AND DURING THE HANGING AND BRACING OF THE DISTRIBUTION SYSTEMS. THE STRUCTURAL ENGINEER OF RECORD SHALL VERIFY THE ADEQUACY OF THE STRUCTURE TO SUPPORT THE HANGER AND BRACE LOADS.

MP ☒ MD ☒ - OPTION 1: DETAILED ON THE APPROVED DRAWINGS WITH PROJECT SPECIFIC NOTES AND DETAILS.

MP ☐ MD ☐ - OPTION 2: SHALL COMPLY WITH THE APPLICABLE OSHPD PRE-APPROVAL OPM

MP ☐ MD ☐ - OPTION 3: SHALL COMPLY WITH THE SMACNA SEISMIC RESTRAINT MANUAL, OSHPD EDITION (2009), INCLUDING ANY ADDENDA. FASTENERS AND OTHER ATTACHMENTS NOT SPECIFICALLY IDENTIFIED IN THE SMACNA SEISMIC RESTRAINT MANUAL, OSHPD EDITION, ARE DETAILED ON THE APPROVED DRAWINGS WITH PROJECT SPECIFIC NOTES AND DETAILS. THE DETAILS SHALL ACCOUNT FOR THE APPLICABLE SEISMIC HAZARD LEVEL AND CONNECTION LEVEL FOR THE PROJECT AND CONDITIONS.

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GENERAL NOTES

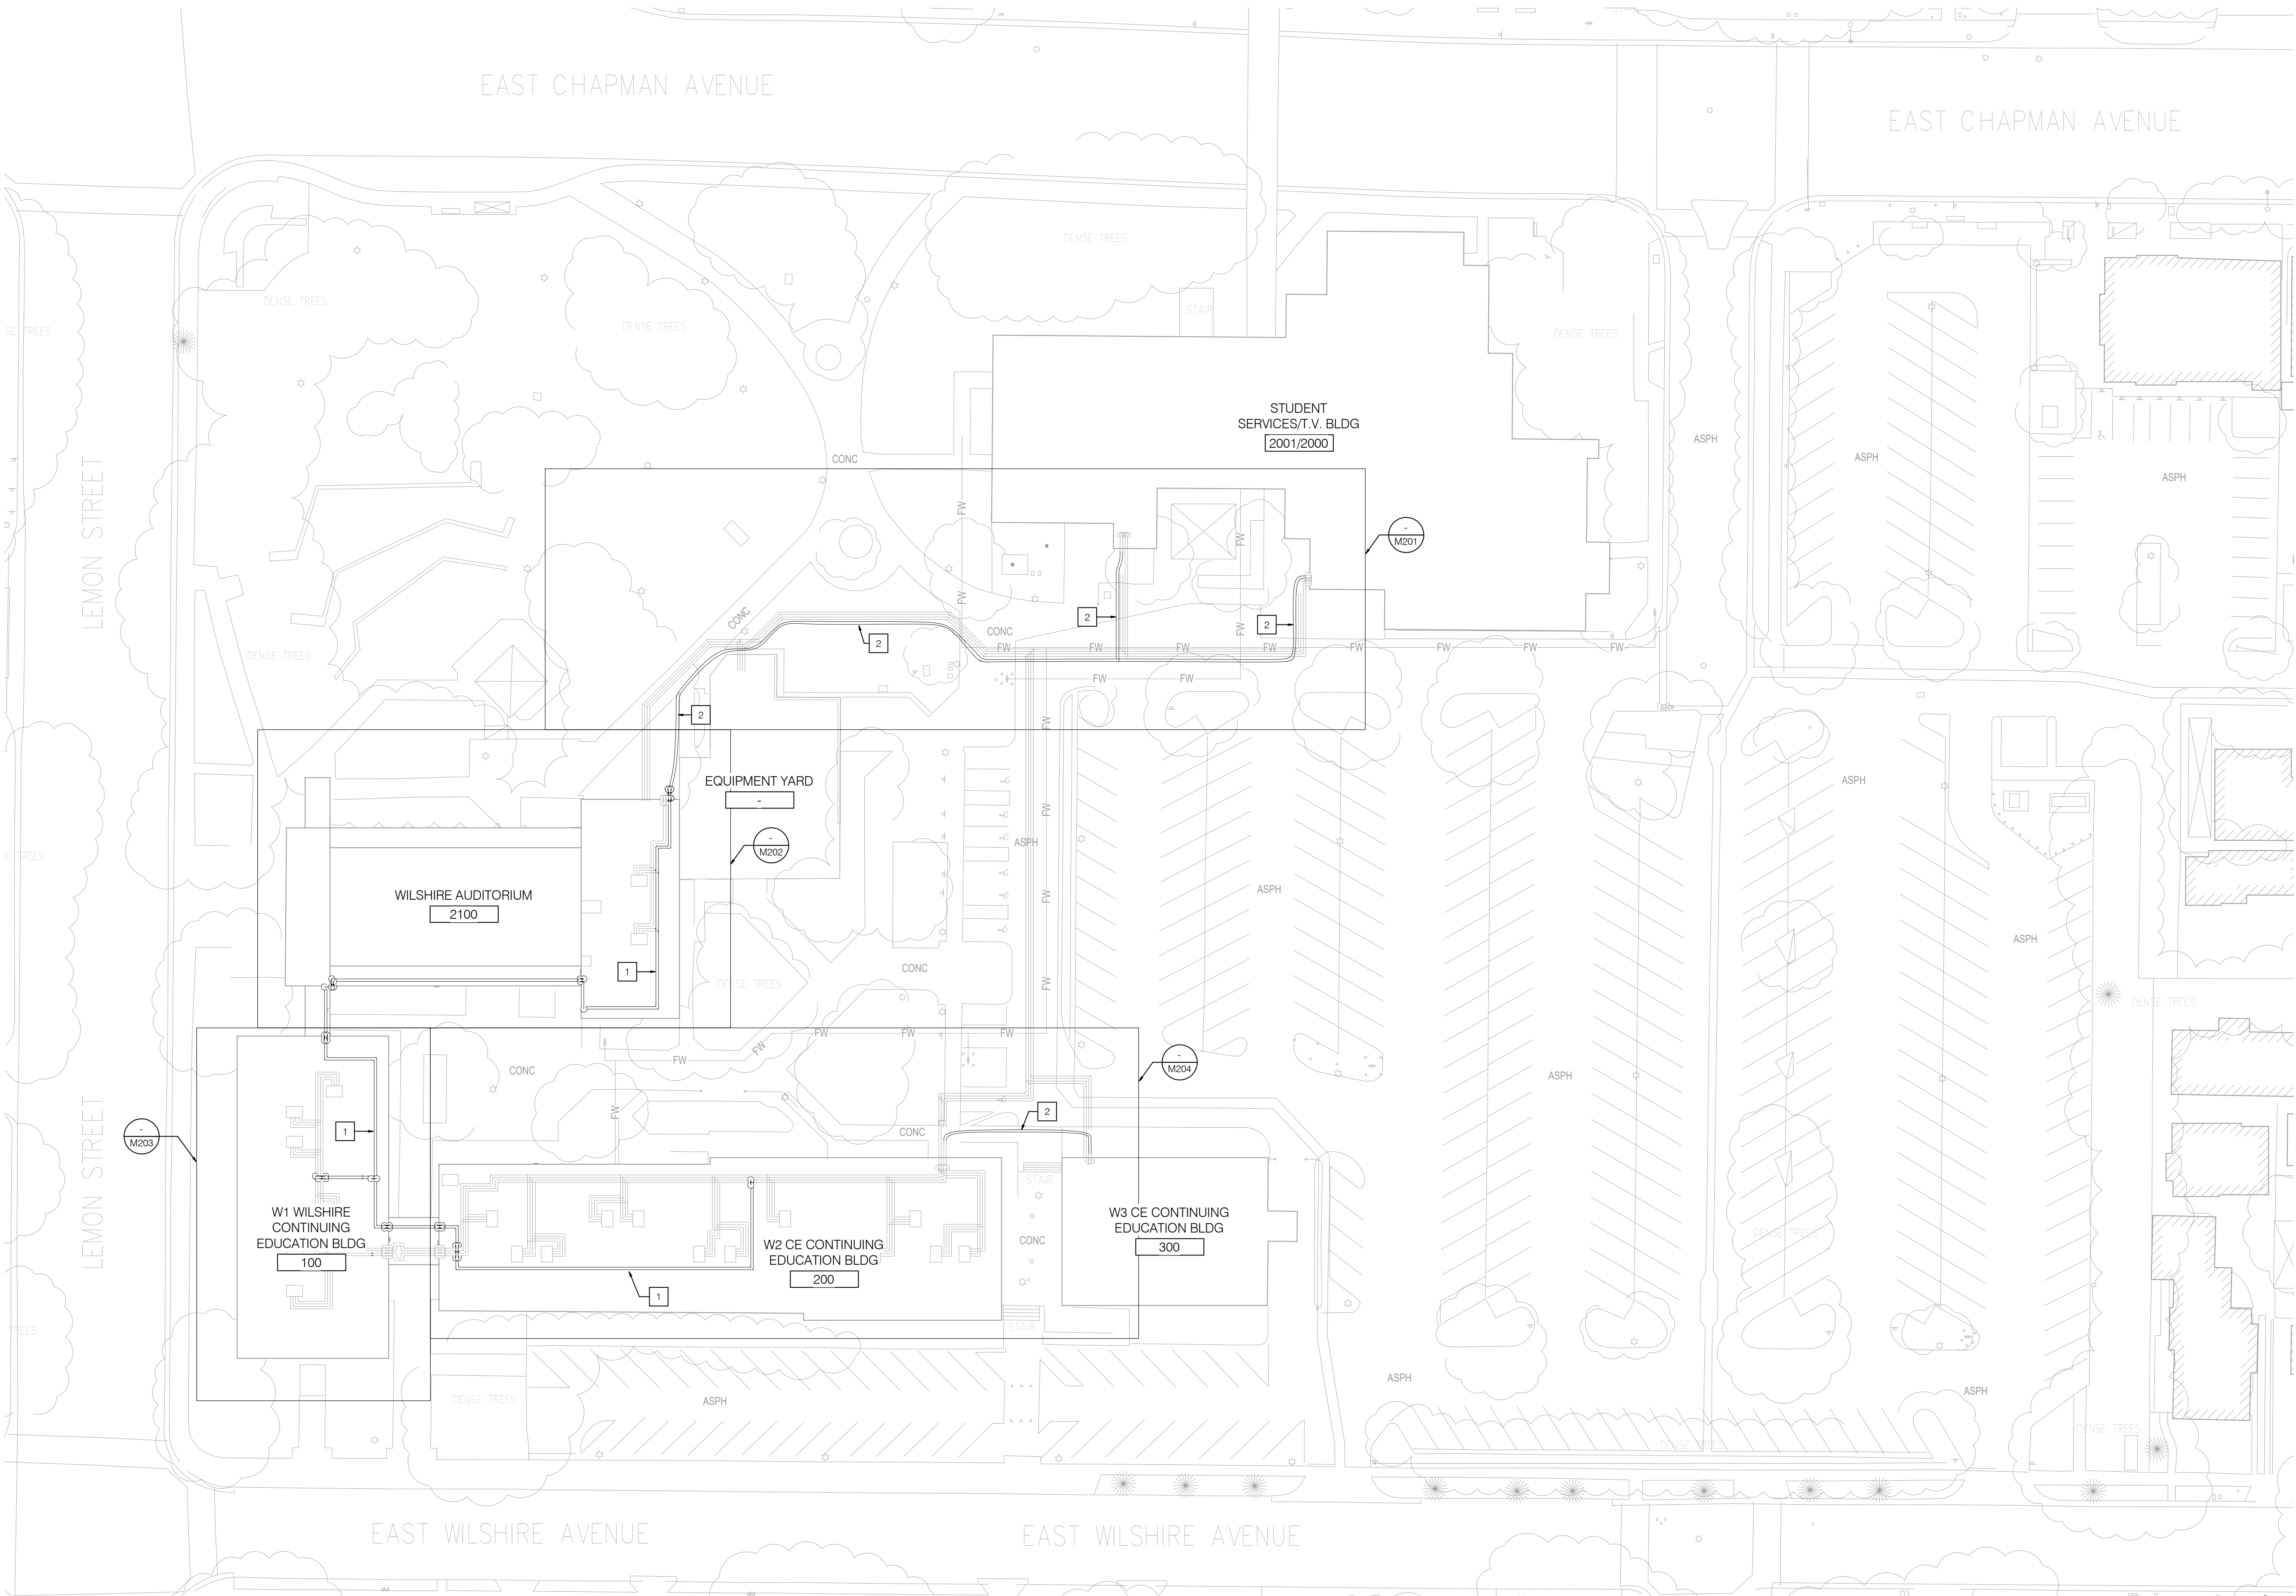1. CUT-INS AND CHANGEOVERS SHALL BE COORDINATED TO MINIMIZE DOWNTIME OF THE HEATING HOT WATER DISTRIBUTION SYSTEM AS MUCH AS POSSIBLE AND WITHOUT DISRUPTING THE DISTRIBUTION OF HHW DURING THE CAMPUS NORMAL HOURS OF OPERATION. ALL CUT-INS AND CHANGEOVERS SHALL OCCUR OVER THE WEEKEND AND WHEN WILSHIRE AUDITORIUM IS NOT IN USE. CONTRACTOR SHALL COORDINATE WITH THE CAMPUS TO SCHEDULE THE DOWNTIME.
2. CONTRACTOR SHALL PERFORM A UTILITY SEARCH PRIOR TO THE START OF ANY CONSTRUCTION OR DEMOLITION IN ORDER TO IDENTIFY ANY EXISTING SYSTEMS OR OBSTRUCTIONS THAT MAY HINDER THE INSTALLATION OF THE DIRECT-BURIED PIPING. THE RESULTS OF THE UTILITY SEARCH MUST BE SUBMITTED TO BOTH THE CAMPUS REPRESENTATIVE AND THE ENGINEER OF RECORD.

NOTES

1. PROVIDE ROOF MOUNTED STEEL PIPING AS SHOWN. PROVIDE ROUTING AS SHOWN TO FOLLOW ALONGSIDE EXISTING HHW PIPES.
2. PROVIDE PREINSULATED DIRECT BURIED PEX PIPING AS SHOWN. PROVIDE ROUTING AS SHOWN TO FOLLOW PLAN AND ELEVATION ROUTING ALONGSIDE EXISTING CHW PIPES. AIR VENTS SHALL BE PROVIDED FOR ALL PEX PIPING INSTALLATIONS AT ALL HIGH POINTS. SEE DETAIL 2/M602.

IDENTIFICATION STAMP
DIV. OF THE STATE ARCHITECT
APP. 04-118731 INC.
REVIEWED FOR
SS ☒ FLS ☒ ACS ☒
DATE: 01.09.20



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Consultant

Project Title
Heating Hot Water
Replacement Parking Lot 10

Owner



321 East Chapman Avenue
Fullerton, CA 92832



Revisions		
Number	Description	Date
	DSA Submittal	10/29/2019
	DSA Back Check	1/8/2020

Designed T Mueller
Drawn T Mueller
Checked C Dean
Approved M Phillips

Date January 8, 2020


Submittal DSA Back Check

Scale 1" = 30'

Sheet Title
Site Plan

Sheet Number
M100

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GENERAL NOTES
1. AUTOMATIC AIR VENTS SHALL BE PROVIDED FOR ALL DIRECT BURIED PEX PIPING INSTALLATIONS AT ALL HIGH POINTS. SEE DETAIL 2/M602.

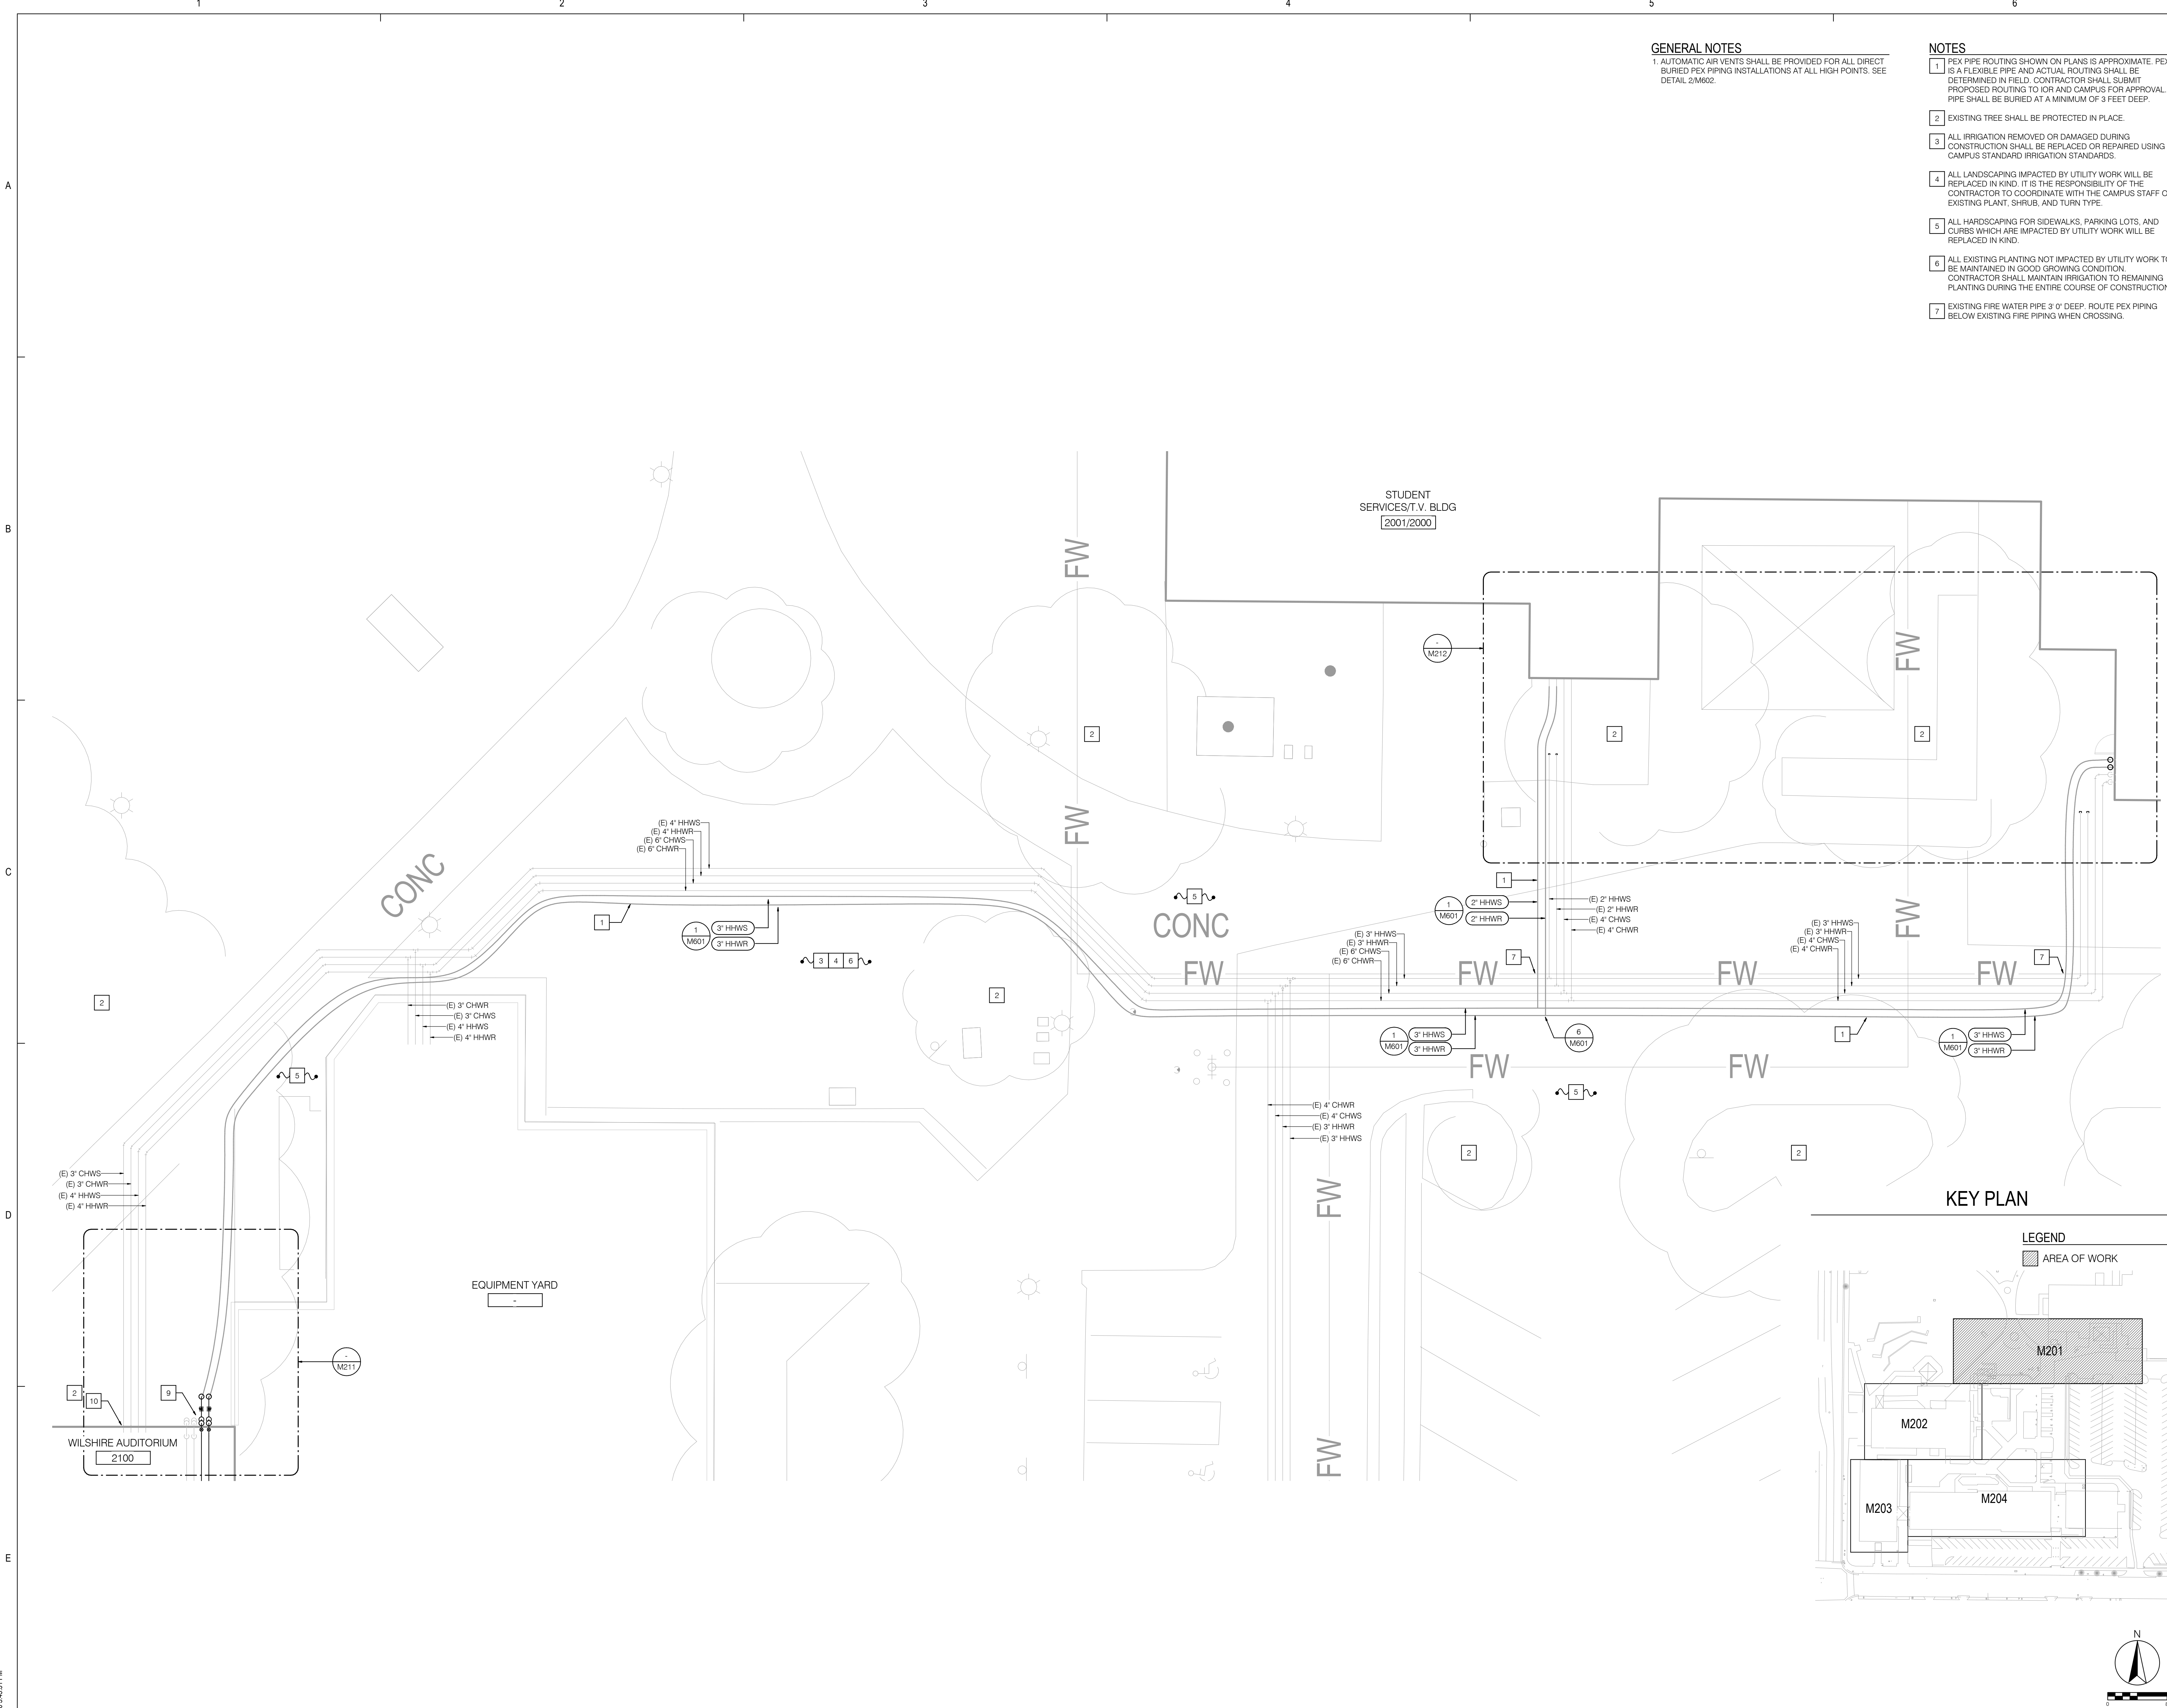- NOTES**
1. PEX PIPE ROUTING SHOWN ON PLANS IS APPROXIMATE. PEX IS A FLEXIBLE PIPE AND ACTUAL ROUTING SHALL BE DETERMINED IN FIELD. CONTRACTOR SHALL SUBMIT PROPOSED ROUTING TO ICR AND CAMPUS FOR APPROVAL. PIPE SHALL BE BURIED AT A MINIMUM OF 3 FEET DEEP.
 2. EXISTING TREE SHALL BE PROTECTED IN PLACE.
 3. ALL IRRIGATION REMOVED OR DAMAGED DURING CONSTRUCTION SHALL BE REPLACED OR REPAIRED USING CAMPUS STANDARD IRRIGATION STANDARDS.
 4. ALL LANDSCAPING IMPACTED BY UTILITY WORK WILL BE REPLACED IN KIND. IT IS THE RESPONSIBILITY OF THE CONTRACTOR TO COORDINATE WITH THE CAMPUS STAFF ON EXISTING PLANT, SHRUB, AND TURN TYPE.
 5. ALL HARDSCAPING FOR SIDEWALKS, PARKING LOTS, AND CURBS WHICH ARE IMPACTED BY UTILITY WORK WILL BE REPLACED IN KIND.
 6. ALL EXISTING PLANTING NOT IMPACTED BY UTILITY WORK TO BE MAINTAINED IN GOOD GROWING CONDITION. CONTRACTOR SHALL MAINTAIN IRRIGATION TO REMAINING PLANTING DURING THE ENTIRE COURSE OF CONSTRUCTION.
 7. EXISTING FIRE WATER PIPE 3' 0" DEEP. ROUTE PEX PIPING BELOW EXISTING FIRE PIPING WHEN CROSSING.

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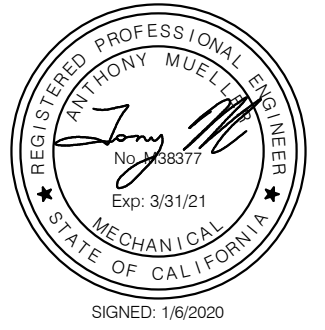
Consultant

Project Title
**Heating Hot Water
Replacement Parking Lot 10**

Owner



321 East Chapman Avenue
Fullerton, CA 92832



Revisions		
Number	Description	Date
1	DSA Submittal	10/29/2019
2	DSA Back Check	1/8/2020

Designed	T Mueller
Drawn	T Mueller
Checked	C Dean
Approved	M Phillips

Date January 8, 2020

Submittal DSA Back Check

Scale 1/8" = 1'-0"


Sheet Title
Enlarged Site Plan

Sheet Number

M201

P2S No. 9570

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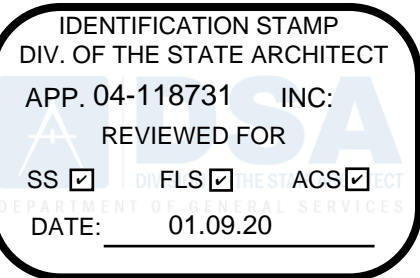


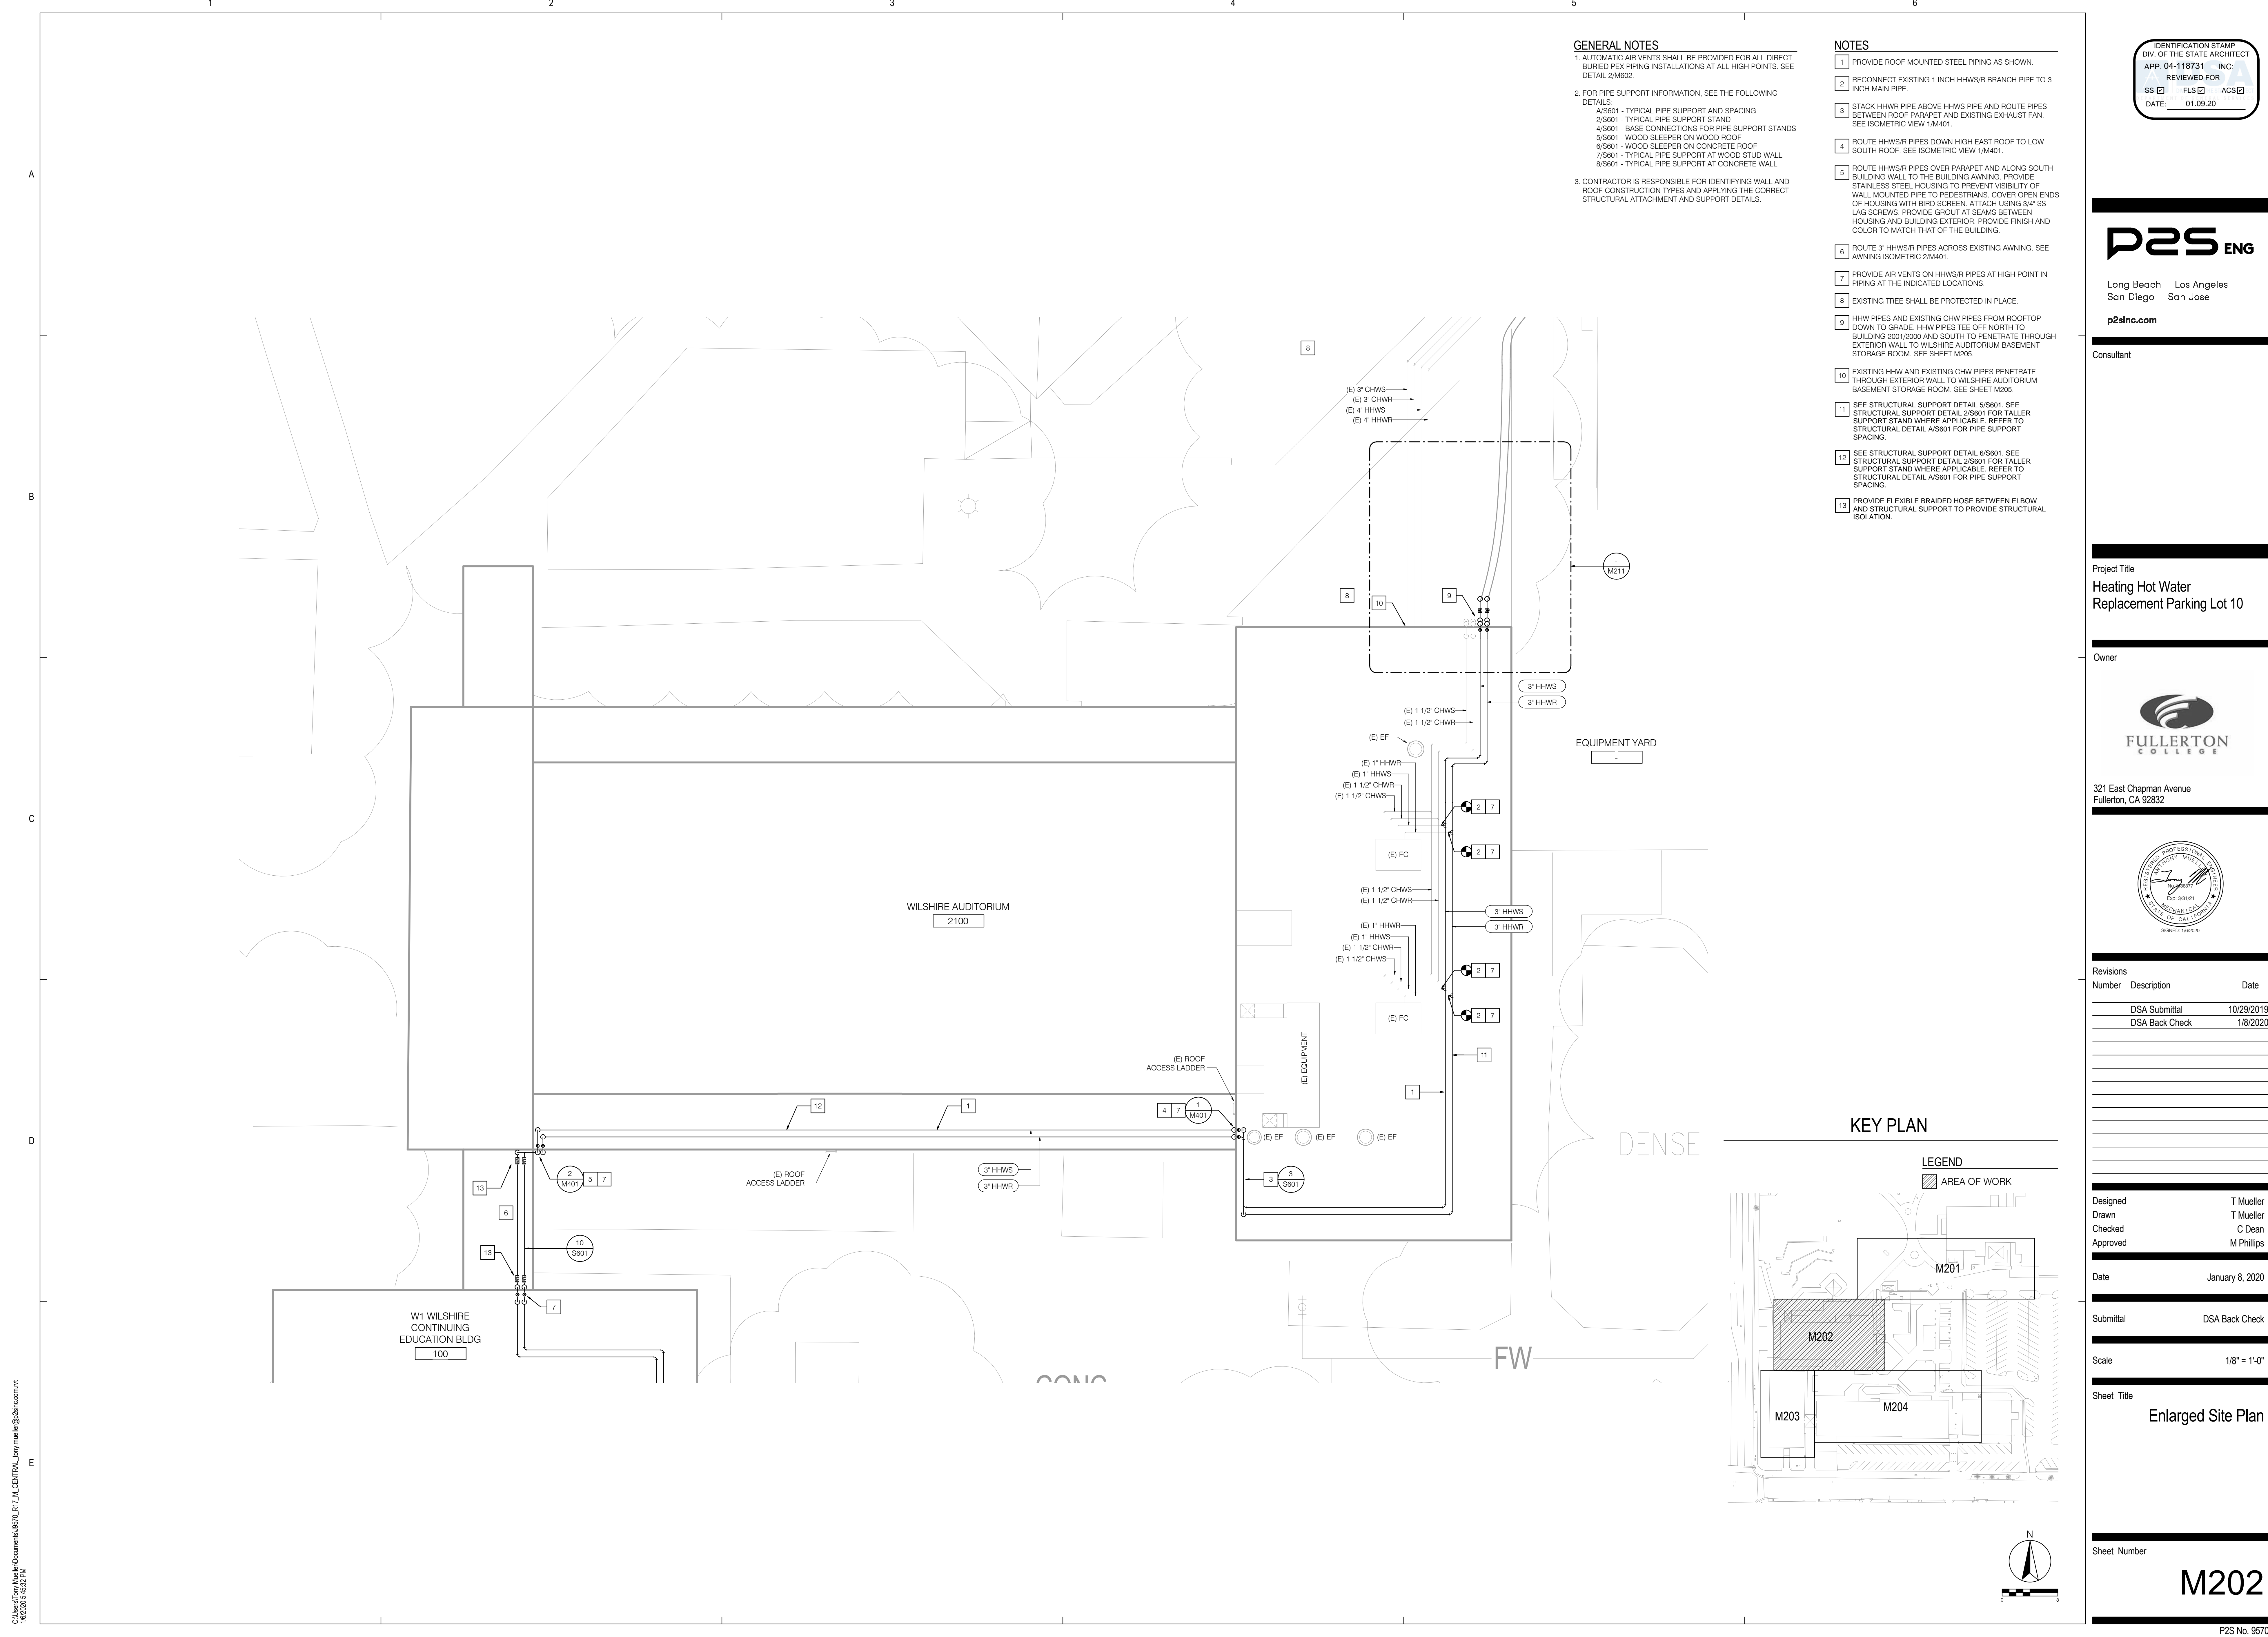GENERAL NOTES

1. AUTOMATIC AIR VENTS SHALL BE PROVIDED FOR ALL DIRECT BURIED PEX PIPING INSTALLATIONS AT ALL HIGH POINTS. SEE DETAIL 2/M602.
2. FOR PIPE SUPPORT INFORMATION, SEE THE FOLLOWING DETAILS:
 - A/S601 - TYPICAL PIPE SUPPORT AND SPACING
 - 2/S601 - TYPICAL PIPE SUPPORT STAND
 - 4/S601 - BASE CONNECTIONS FOR PIPE SUPPORT STANDS
 - 5/S601 - WOOD SLEEPER ON WOOD ROOF
 - 6/S601 - WOOD SLEEPER ON CONCRETE ROOF
 - 7/S601 - TYPICAL PIPE SUPPORT AT WOOD STUD WALL
 - 8/S601 - TYPICAL PIPE SUPPORT AT CONCRETE WALL
3. CONTRACTOR IS RESPONSIBLE FOR IDENTIFYING WALL AND ROOF CONSTRUCTION TYPES AND APPLYING THE CORRECT STRUCTURAL ATTACHMENT AND SUPPORT DETAILS.

NOTES

1. PROVIDE ROOF MOUNTED STEEL PIPING AS SHOWN.
2. RECONNECT EXISTING 1 INCH HHWS/R BRANCH PIPE TO 3 INCH MAIN PIPE.
3. STACK HHWR PIPE ABOVE HHWS PIPE AND ROUTE PIPES BETWEEN ROOF PARAPET AND EXISTING EXHAUST FAN. SEE ISOMETRIC VIEW 1/M401.
4. ROUTE HHWS/R PIPES DOWN HIGH EAST ROOF TO LOW SOUTH ROOF. SEE ISOMETRIC VIEW 1/M401.
5. ROUTE HHWS/R PIPES OVER PARAPET AND ALONG SOUTH BUILDING WALL TO THE BUILDING AWNING. PROVIDE STAINLESS STEEL HOUSING TO PREVENT VISIBILITY OF WALL MOUNTED PIPE TO PEDESTRIANS. COVER OPEN ENDS OF HOUSING WITH BIRD SCREEN. ATTACH USING 3/4" SS LAG SCREWS. PROVIDE GROUT AT SEAMS BETWEEN HOUSING AND BUILDING EXTERIOR. PROVIDE FINISH AND COLOR TO MATCH THAT OF THE BUILDING.
6. ROUTE 3" HHWS/R PIPES ACROSS EXISTING AWNING. SEE AWNING ISOMETRIC 2/M401.
7. PROVIDE AIR VENTS ON HHWS/R PIPES AT HIGH POINT IN PIPING AT THE INDICATED LOCATIONS.
8. EXISTING TREE SHALL BE PROTECTED IN PLACE.
9. HHW PIPES AND EXISTING CHW PIPES FROM ROOFTOP DOWN TO GRADE. HHW PIPES TEE OFF NORTH TO BUILDING 2001/2000 AND SOUTH TO PENETRATE THROUGH EXTERIOR WALL TO WILSHIRE AUDITORIUM BASEMENT STORAGE ROOM. SEE SHEET M205.
10. EXISTING HHW AND EXISTING CHW PIPES PENETRATE THROUGH EXTERIOR WALL TO WILSHIRE AUDITORIUM BASEMENT STORAGE ROOM. SEE SHEET M205.
11. SEE STRUCTURAL SUPPORT DETAIL 5/S601. SEE STRUCTURAL SUPPORT DETAIL 2/S601 FOR TALLER SUPPORT STAND WHERE APPLICABLE. REFER TO STRUCTURAL DETAIL A/S601 FOR PIPE SUPPORT SPACING.
12. SEE STRUCTURAL SUPPORT DETAIL 6/S601. SEE STRUCTURAL SUPPORT DETAIL 2/S601 FOR TALLER SUPPORT STAND WHERE APPLICABLE. REFER TO STRUCTURAL DETAIL A/S601 FOR PIPE SUPPORT SPACING.
13. PROVIDE FLEXIBLE BRAIDED HOSE BETWEEN ELBOW AND STRUCTURAL SUPPORT TO PROVIDE STRUCTURAL ISOLATION.



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Project Title
Heating Hot Water
Replacement Parking Lot 10

Owner



321 East Chapman Avenue
Fullerton, CA 92832



Revisions		
Number	Description	Date
1	DSA Submittal	10/29/2019
2	DSA Back Check	1/8/2020

Designed T Mueller
Drawn T Mueller
Checked C Dean
Approved M Phillips

Date January 8, 2020

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Scale 1/8" = 1'-0"

Sheet Title
Enlarged Site Plan

Sheet Number

M202

P2S No. 9570

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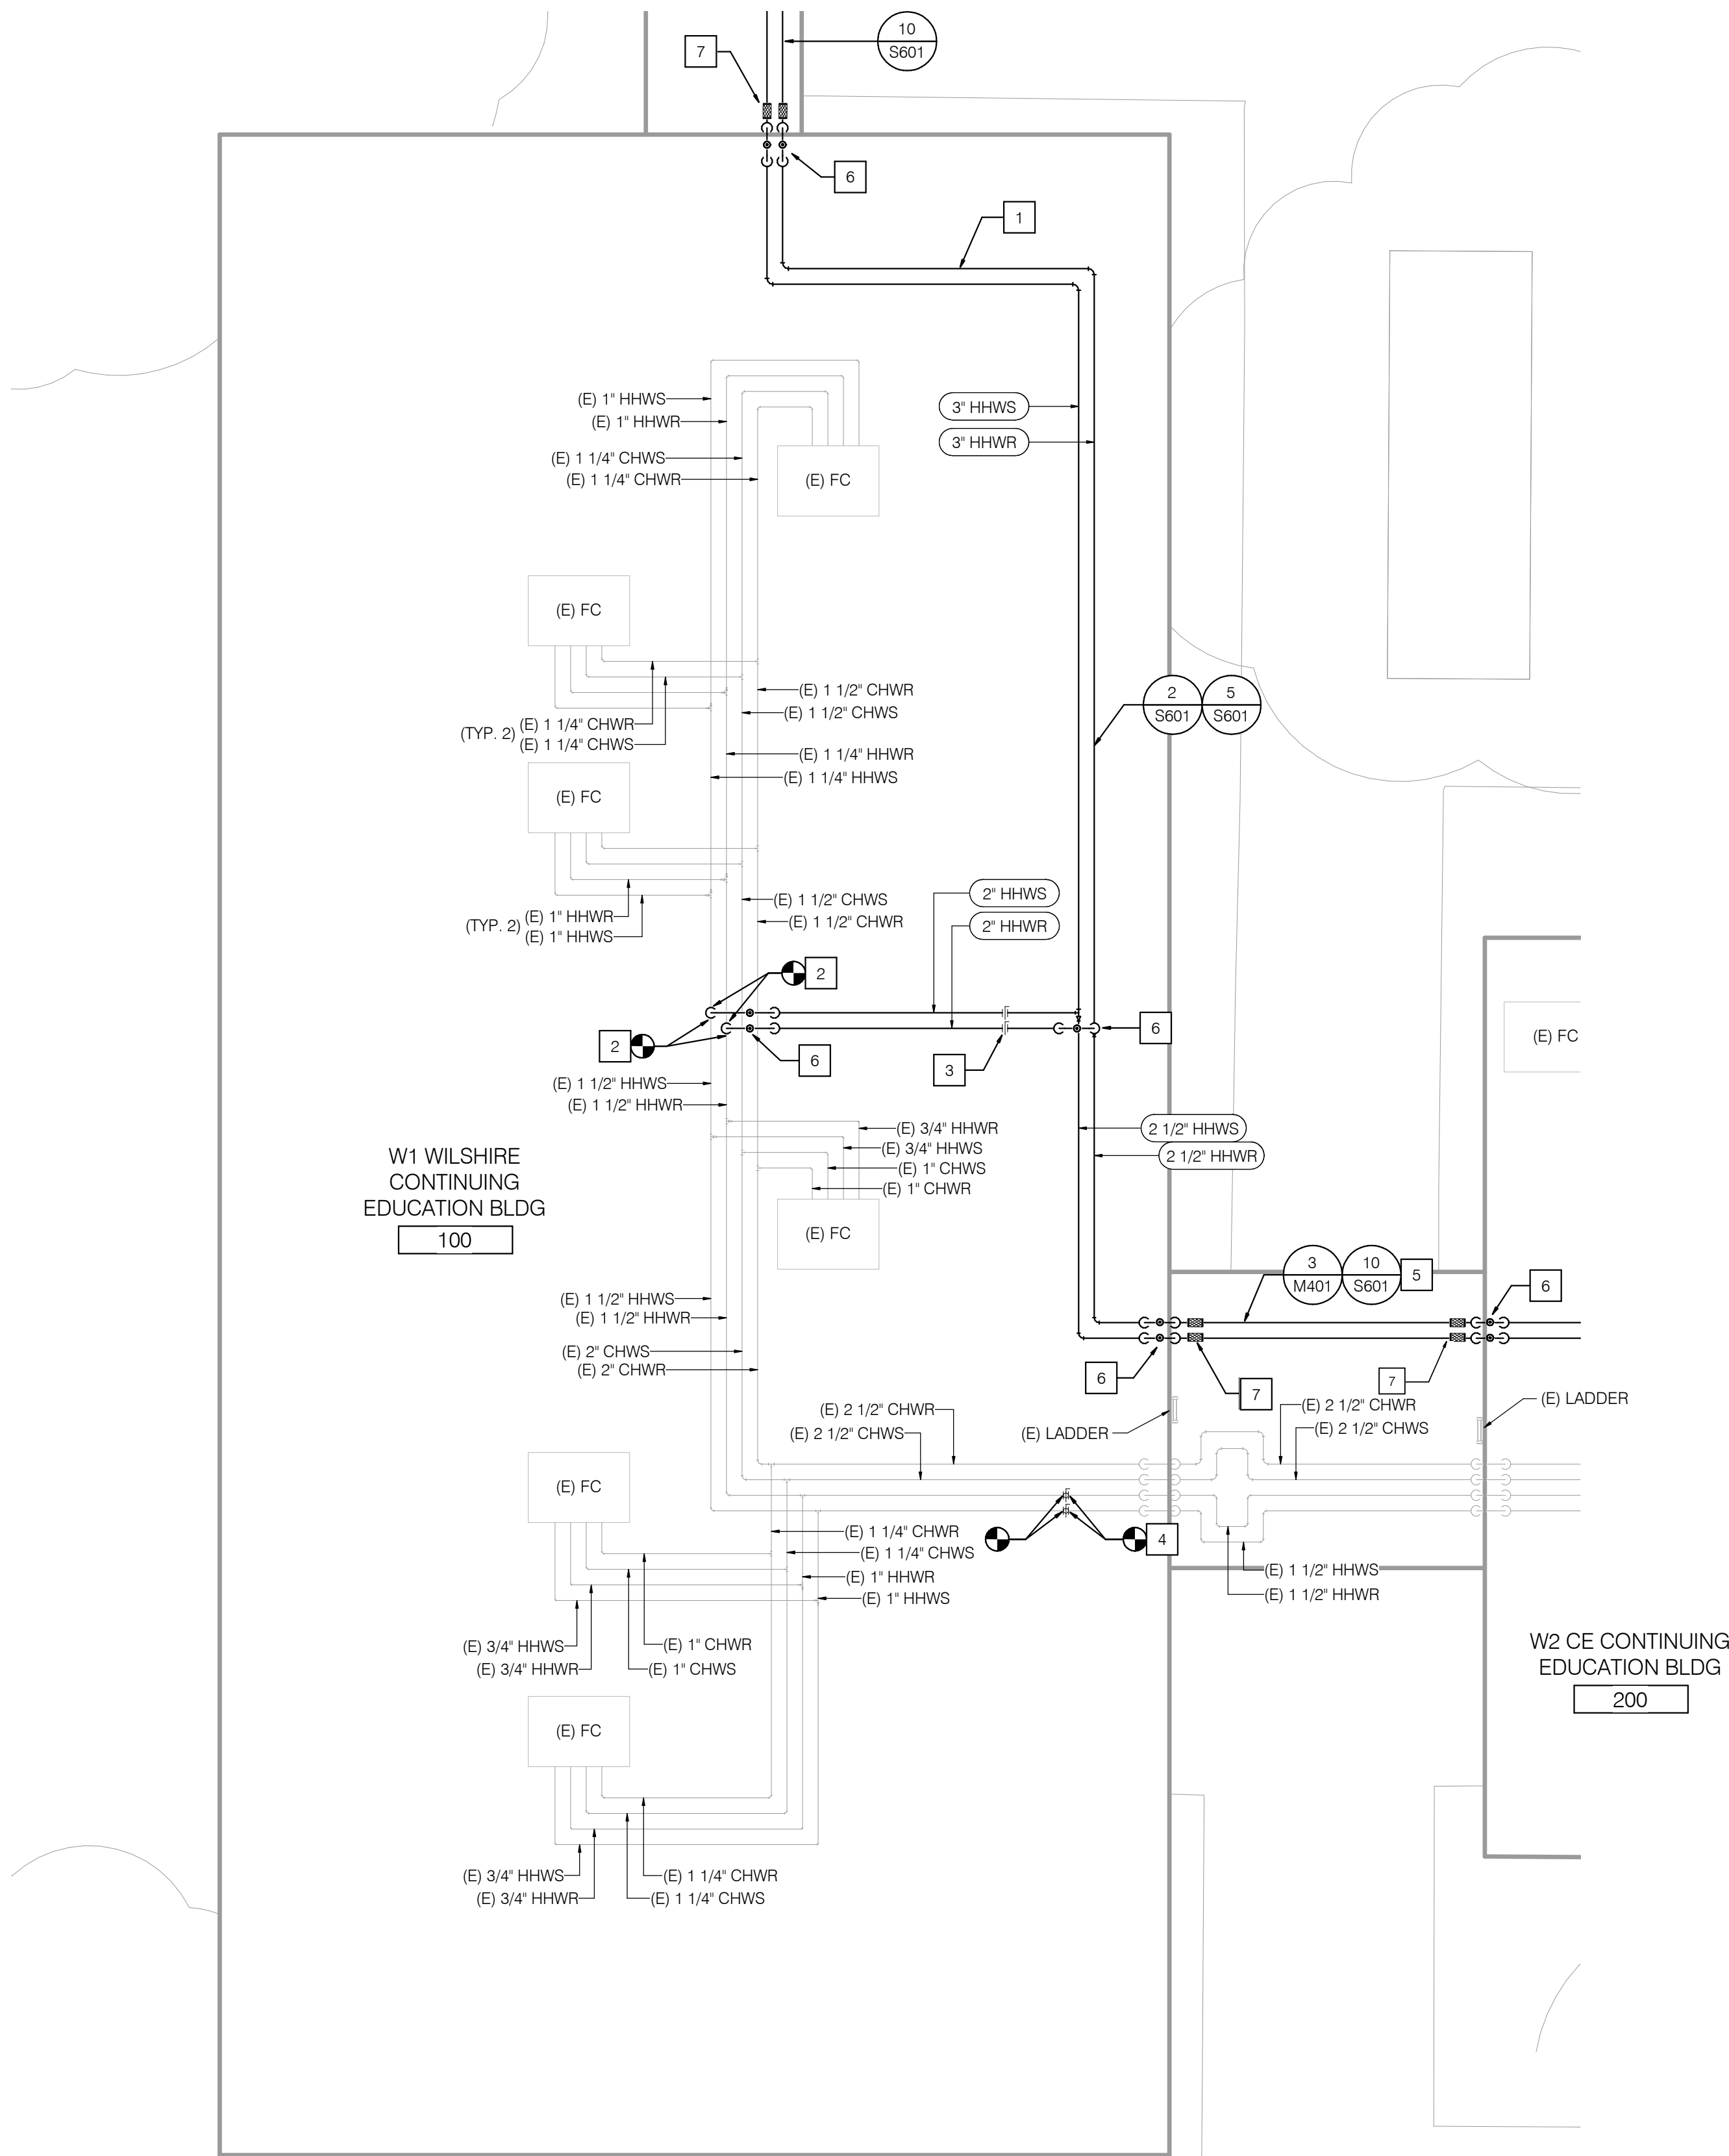
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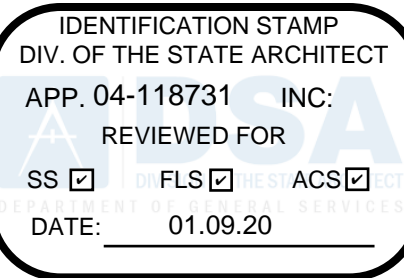
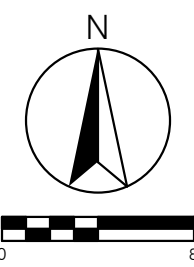
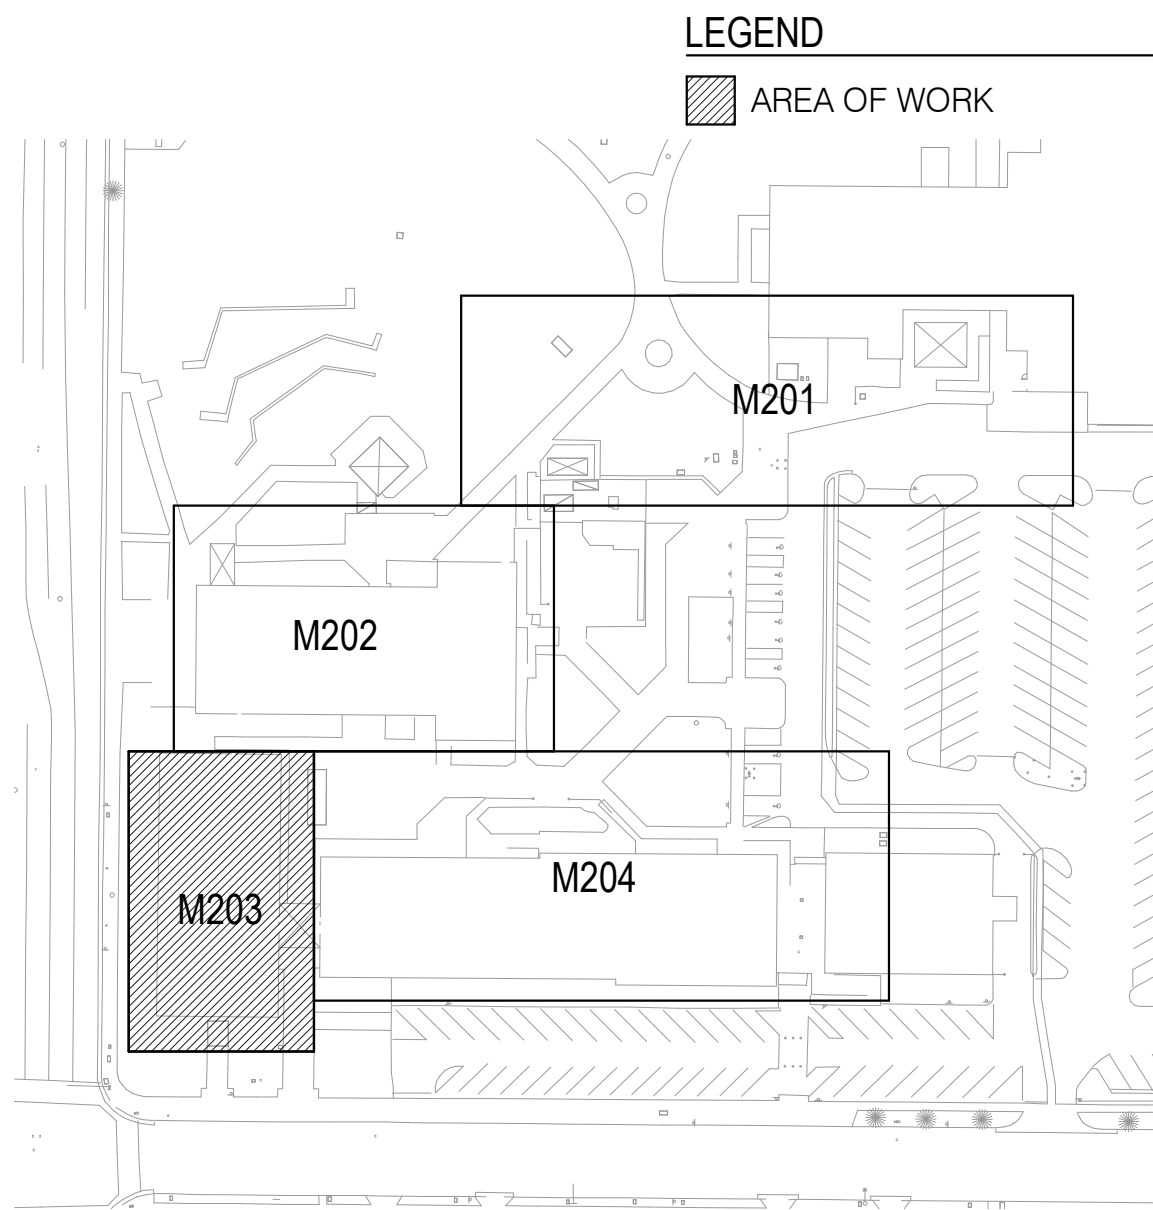
GENERAL NOTES

1. AUTOMATIC AIR VENTS SHALL BE PROVIDED FOR ALL DIRECT BURIED PEX PIPING INSTALLATIONS AT ALL HIGH POINTS. SEE DETAIL 2/M602.
2. FOR PIPE SUPPORT INFORMATION, SEE THE FOLLOWING DETAILS:
A/S601 - TYPICAL PIPE SUPPORT AND SPACING
2/S601 - TYPICAL PIPE SUPPORT STAND
4/S601 - BASE CONNECTIONS FOR PIPE SUPPORT STANDS
5/S601 - WOOD SLEEPER ON WOOD ROOF
6/S601 - WOOD SLEEPER ON CONCRETE ROOF
7/S601 - TYPICAL PIPE SUPPORT AT WOOD STUD WALL
8/S601 - TYPICAL PIPE SUPPORT AT CONCRETE WALL
3. CONTRACTOR IS RESPONSIBLE FOR IDENTIFYING WALL AND ROOF CONSTRUCTION TYPES AND APPLYING THE CORRECT STRUCTURAL ATTACHMENT AND SUPPORT DETAILS.

NOTES

1. PROVIDE ROOF MOUNTED STEEL PIPING AS SHOWN.
2. CUT IN AND PROVIDE 2 INCH TEE AND REDUCERS TO CONNECT TO EXISTING 1-1/2 INCH HHWS AND HHWR PIPES.
3. PROVIDE 2 INCH BUTTERFLY VALVES ON HHWS/R PIPES AS INDICATED FOR ISOLATION OF BUILDING 100.
4. CUT IN AND PROVIDE 1-1/2 INCH FULL PORT BALL VALVE ON HHWS/R PIPES AS INDICATED FOR ISOLATION OF BUILDING 100 OR BUILDING 200.
5. ROUTE 3\"/>

KEY PLAN



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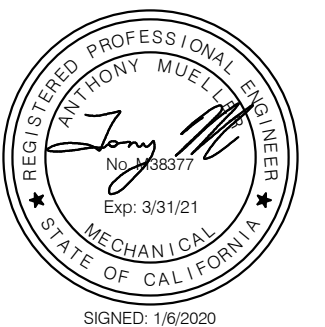
Consultant

Project Title
Heating Hot Water
Replacement Parking Lot 10

Owner



321 East Chapman Avenue
Fullerton, CA 92832



Revisions		
Number	Description	Date
	DSA Submittal	10/29/2019
	DSA Back Check	1/8/2020

Designed	T Mueller
Drawn	T Mueller
Checked	C Dean
Approved	M Phillips

Date January 8, 2020

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Scale 1/8" = 1'-0"

Sheet Title
Enlarged Site Plan

Sheet Number

M203

P2S No. 9570

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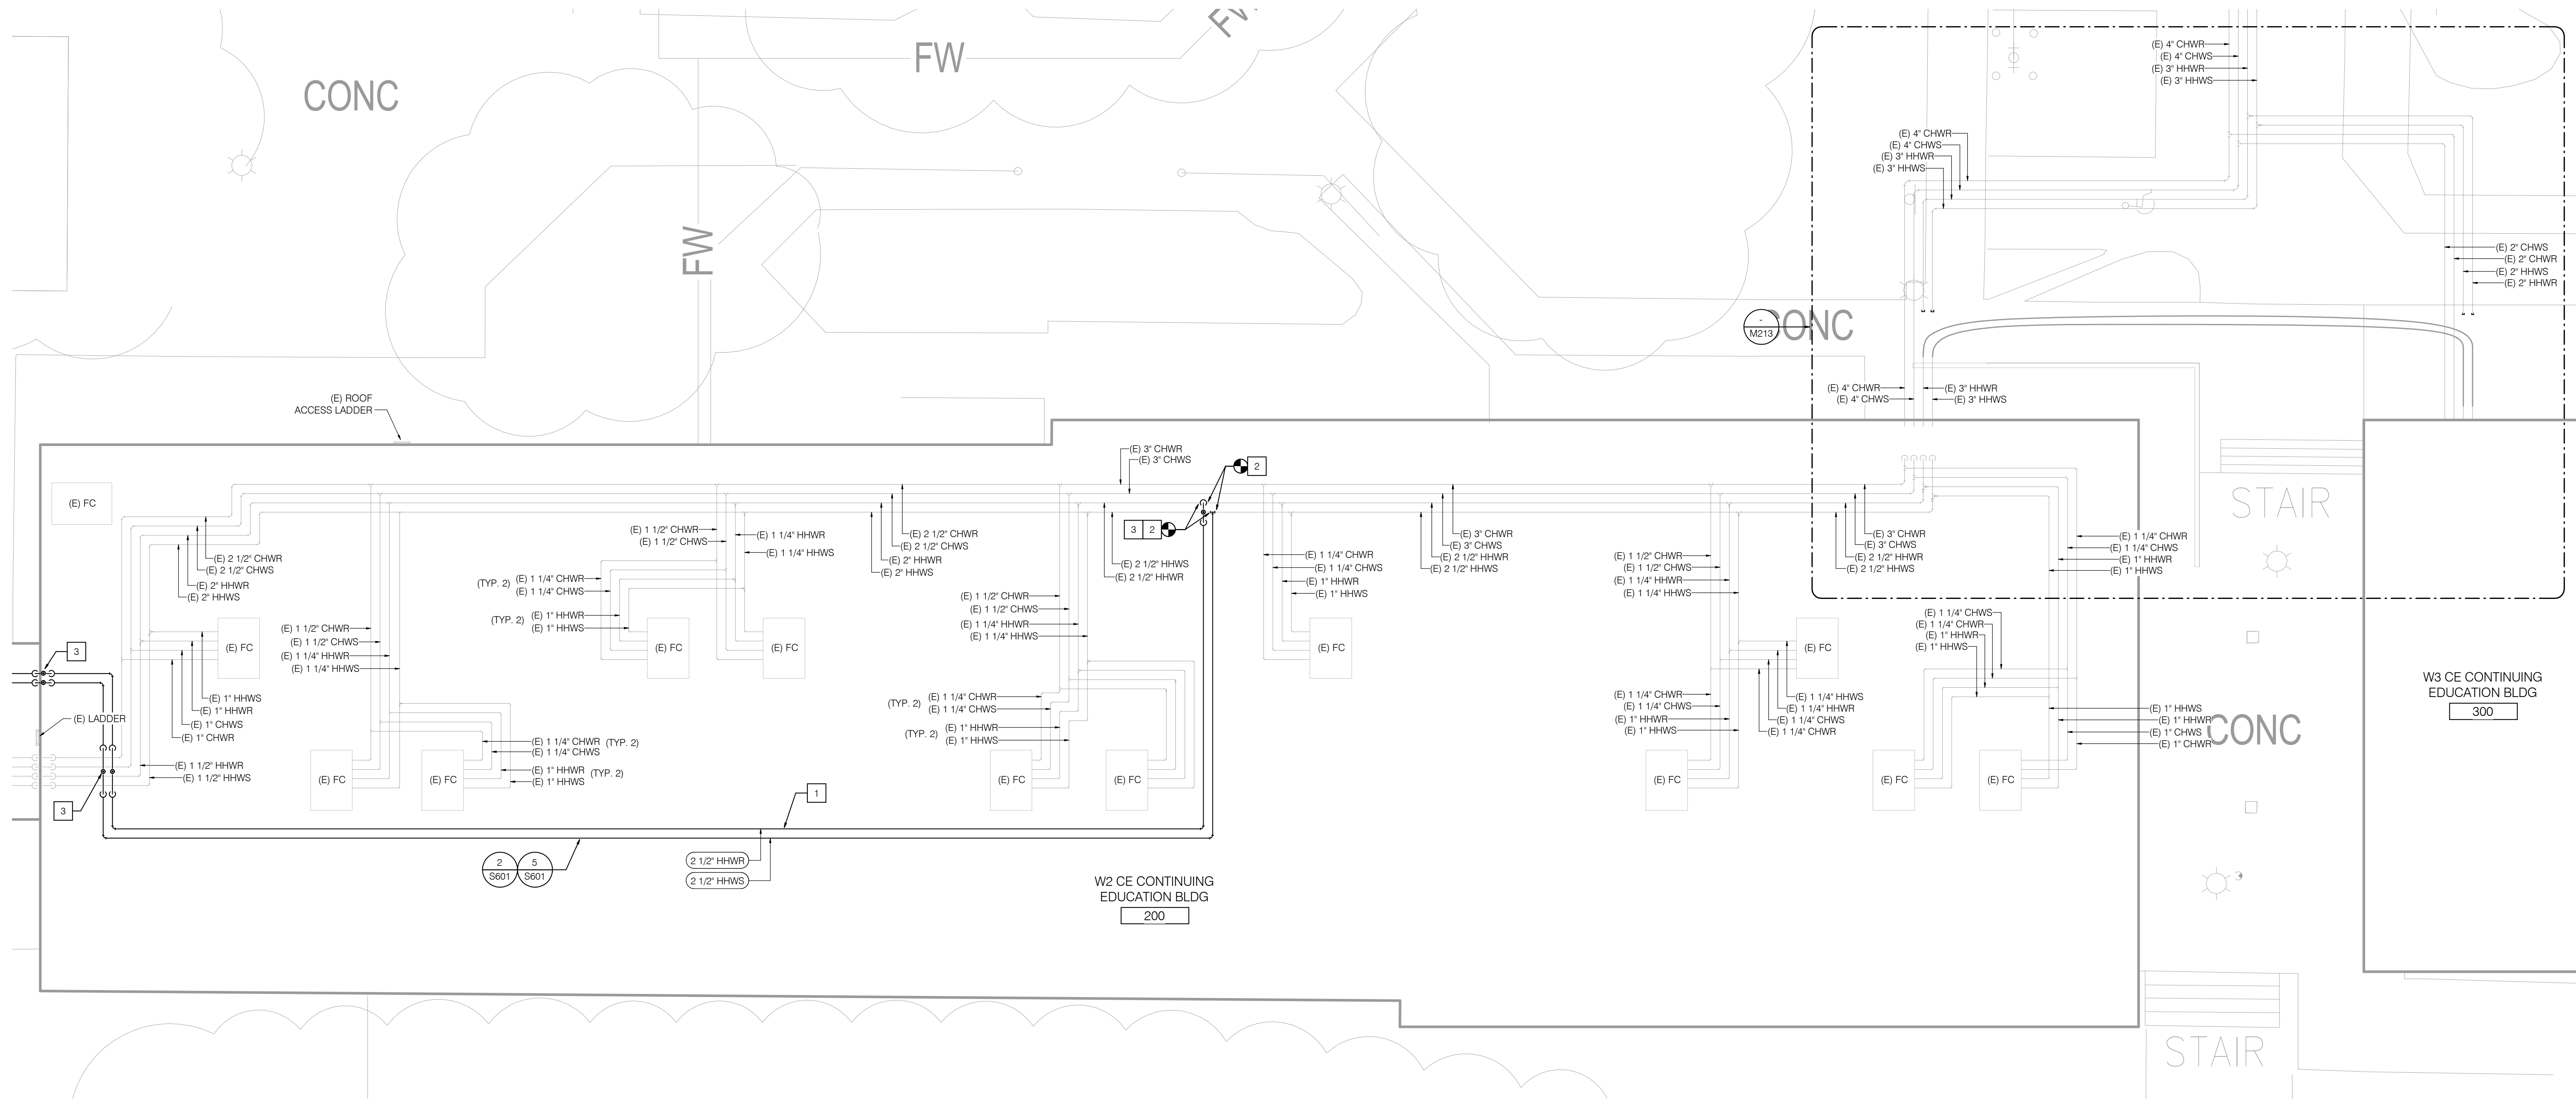
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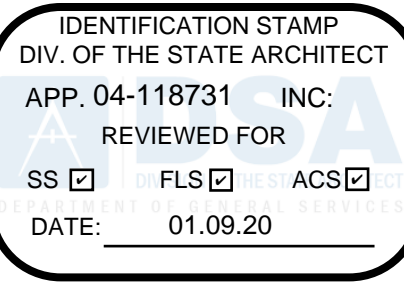


GENERAL NOTES

1. AUTOMATIC AIR VENTS SHALL BE PROVIDED FOR ALL DIRECT BURIED PEX PIPING INSTALLATIONS AT ALL HIGH POINTS. SEE DETAIL 2/M602.
2. FOR PIPE SUPPORT INFORMATION, SEE THE FOLLOWING DETAILS:
A/5601 - TYPICAL PIPE SUPPORT AND SPACING
2/5601 - TYPICAL PIPE SUPPORT STAND
4/5601 - BASE CONNECTIONS FOR PIPE SUPPORT STANDS
5/5601 - WOOD SLEEPER ON WOOD ROOF
6/5601 - WOOD SLEEPER ON CONCRETE ROOF
7/5601 - TYPICAL PIPE SUPPORT AT WOOD STUD WALL
8/5601 - TYPICAL PIPE SUPPORT AT CONCRETE WALL
3. CONTRACTOR IS RESPONSIBLE FOR IDENTIFYING WALL AND ROOF CONSTRUCTION TYPES AND APPLYING THE CORRECT STRUCTURAL ATTACHMENT AND SUPPORT DETAILS.

NOTES

1. PROVIDE ROOF MOUNTED STEEL PIPING AS SHOWN.
2. CONNECT 2-1/2 INCH HHWS AND HHWR PIPE TO EXISTING 2-1/2 INCH HHWS AND HHWR PIPES.
3. PROVIDE AIR VENTS ON HHWS/R PIPES AT HIGH POINT IN PIPING AT THE INDICATED LOCATIONS.



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1	DSA Submittal	10/29/2019
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Designed	T Mueller
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Approved	M Phillips

Date January 8, 2020

Submittal DSA Back Check

Scale 1/8" = 1'-0"

Sheet Title
Enlarged Site Plan

Sheet Number



M204

P2S No. 9570

KEY PLAN

LEGEND

AREA OF WORK

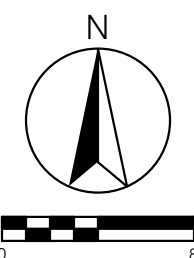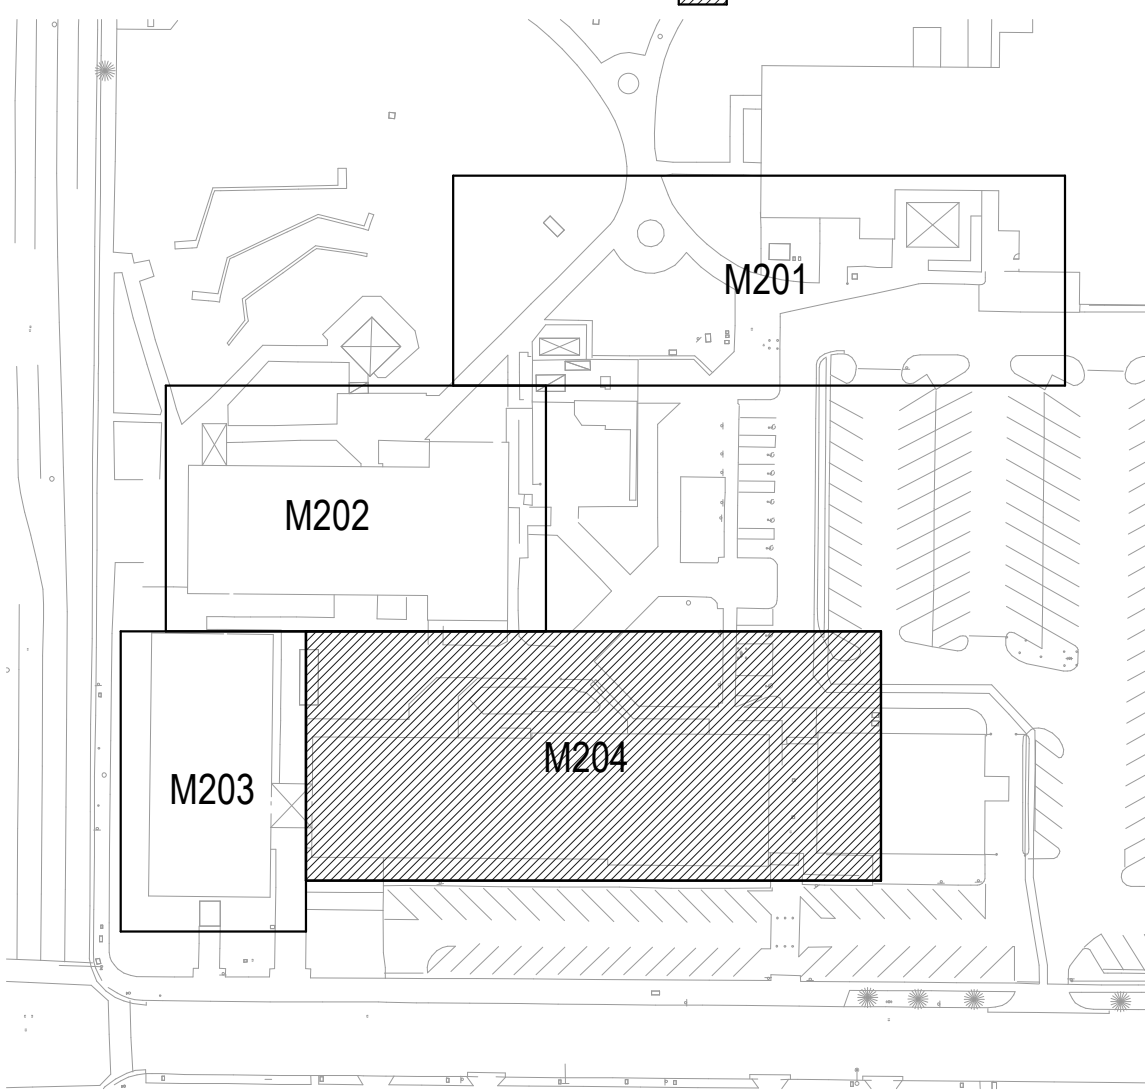

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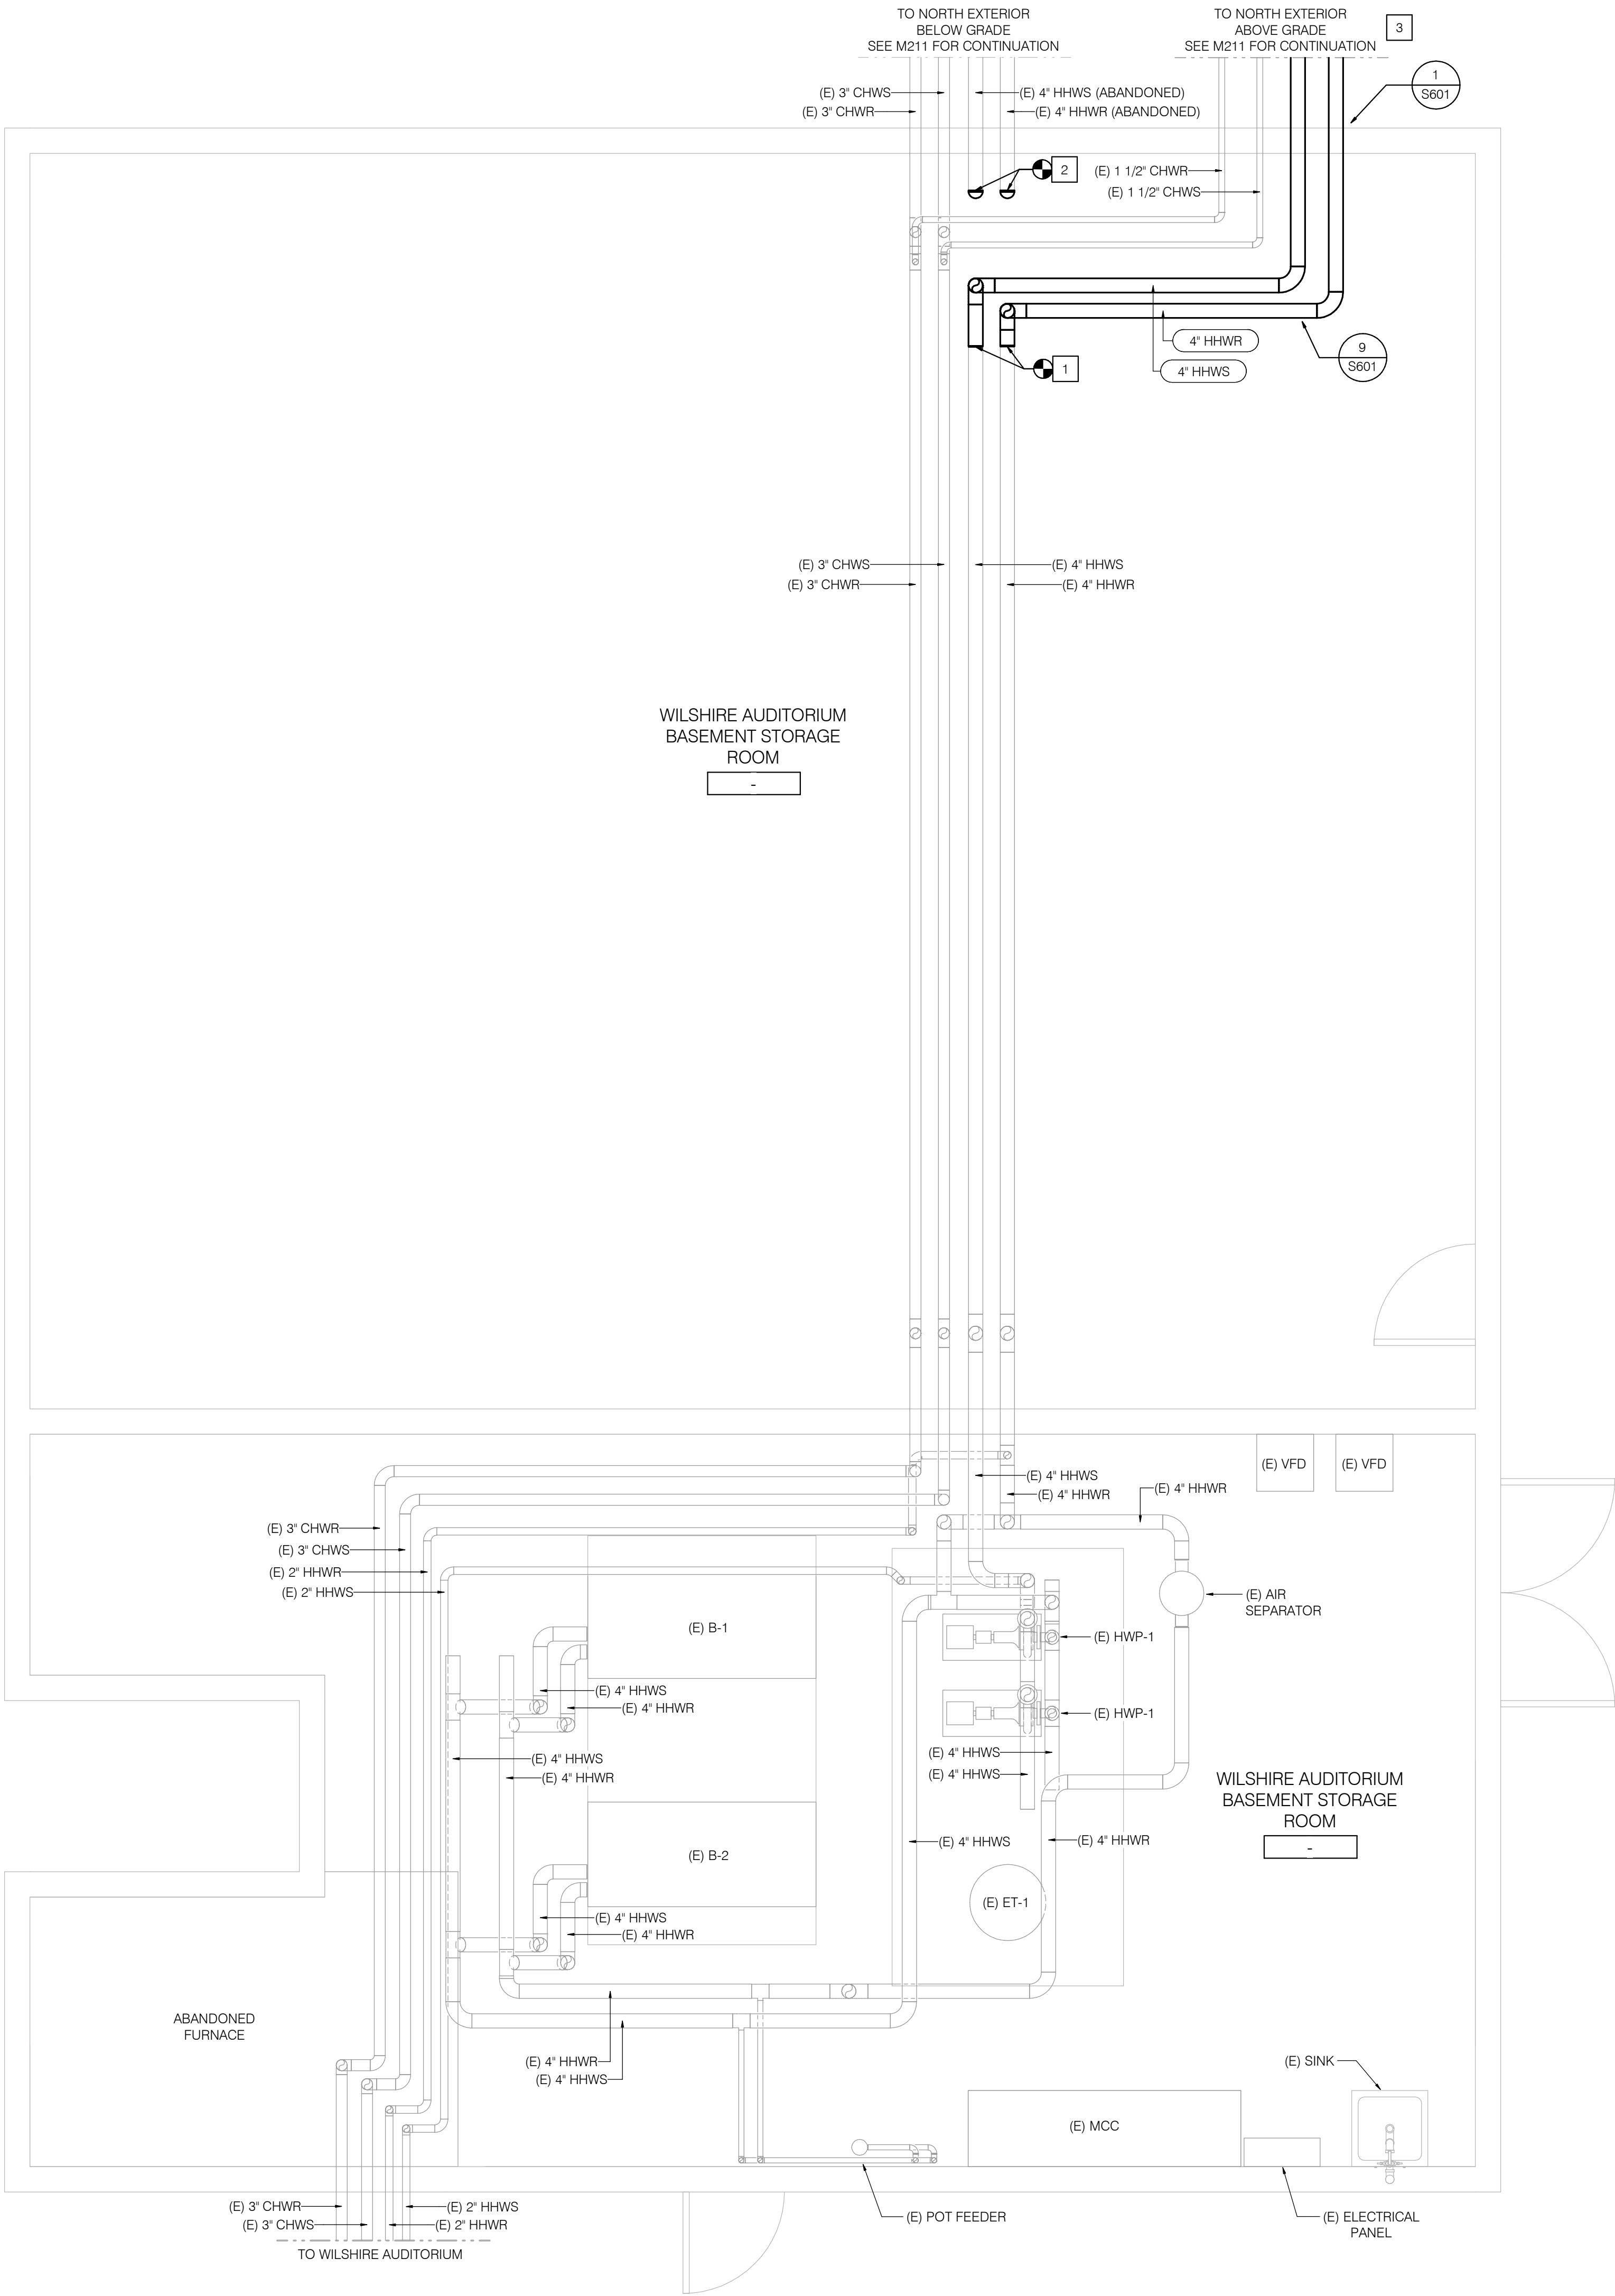
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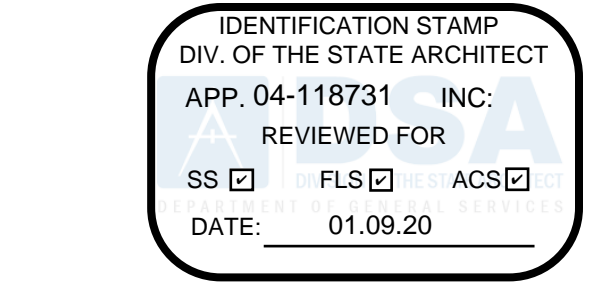
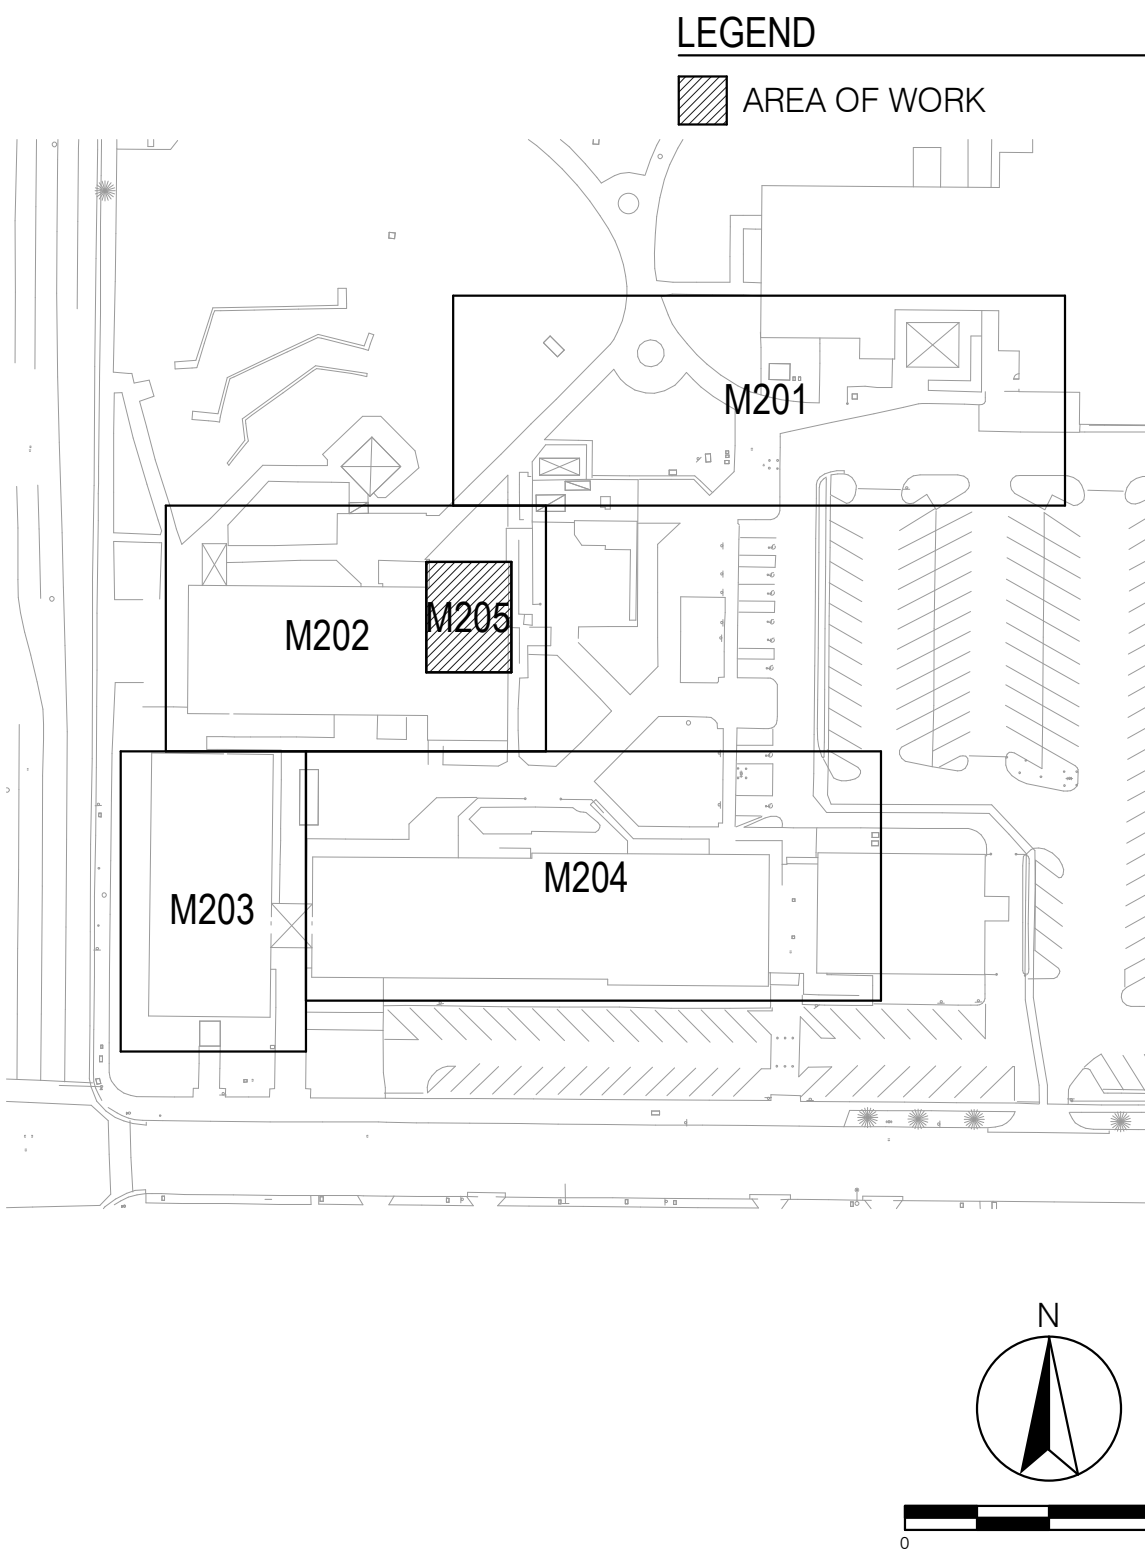
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CONNECT 4\"/>
- 2

CAP (E) HHWS/R PIPES AND ABANDON IN PLACE. REFER TO PIPE SIZES INDICATED ON THE PLANS.
- 3

3\"/>

KEY PLAN



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	DSA Submittal	10/29/2019
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Drawn	T Mueller
Checked	C Dean
Approved	M Phillips

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Scale 3/8" = 1'-0"

Sheet Title
Wilshire Auditorium
Building 2100 - Basement

Sheet Number

M205

P2S No. 9570

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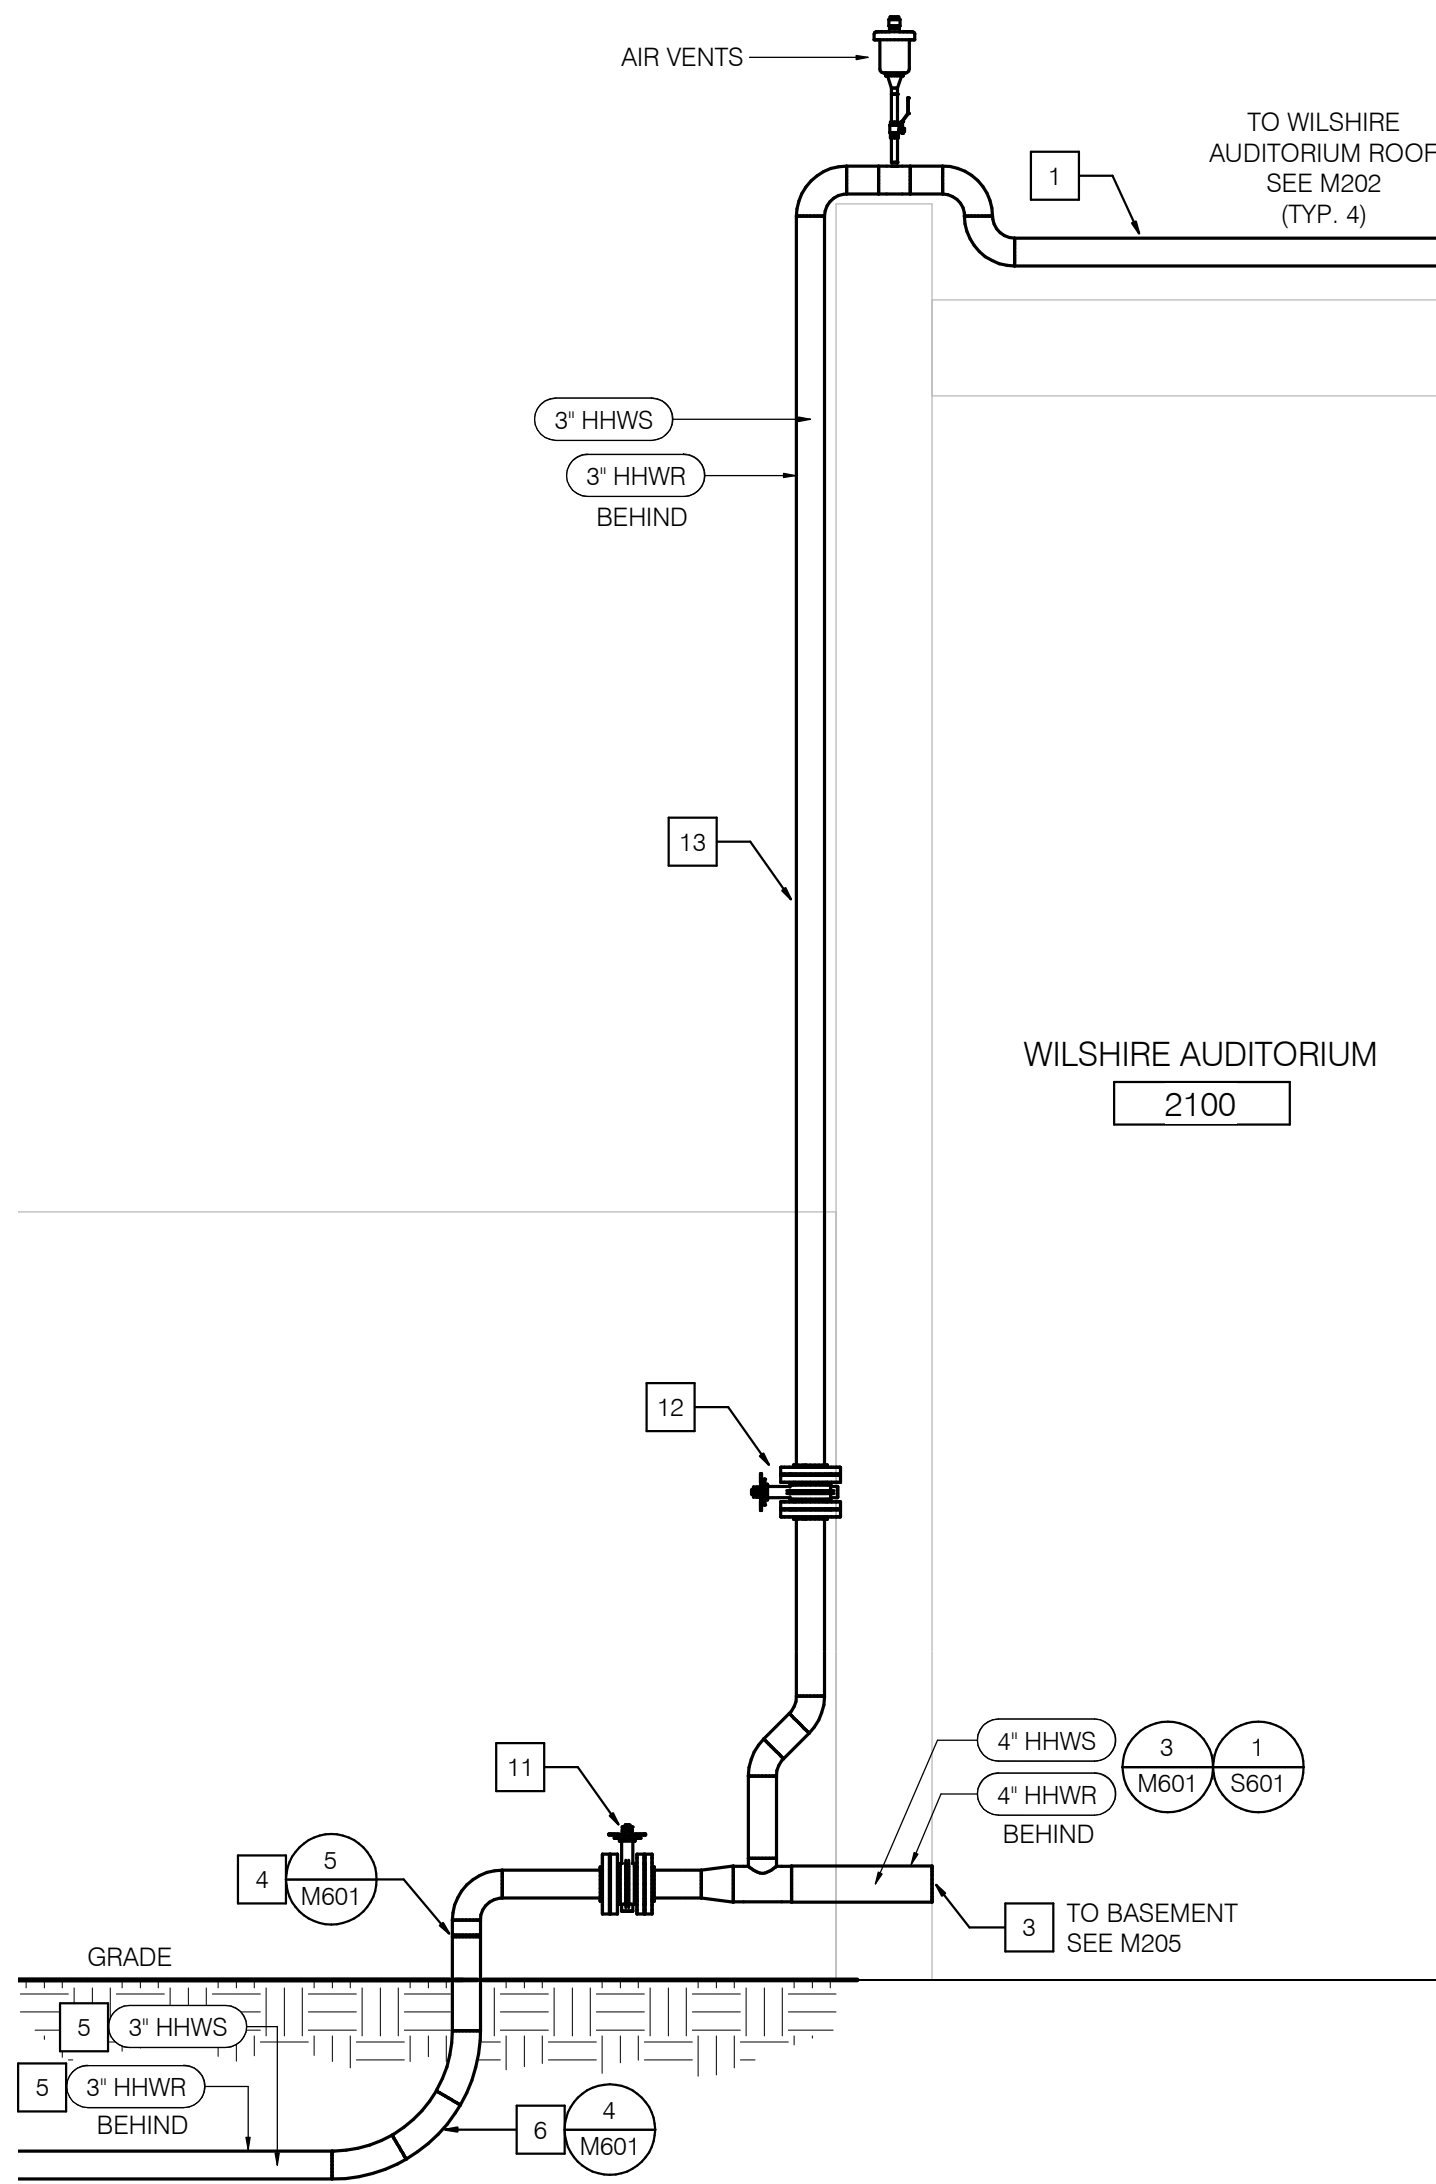
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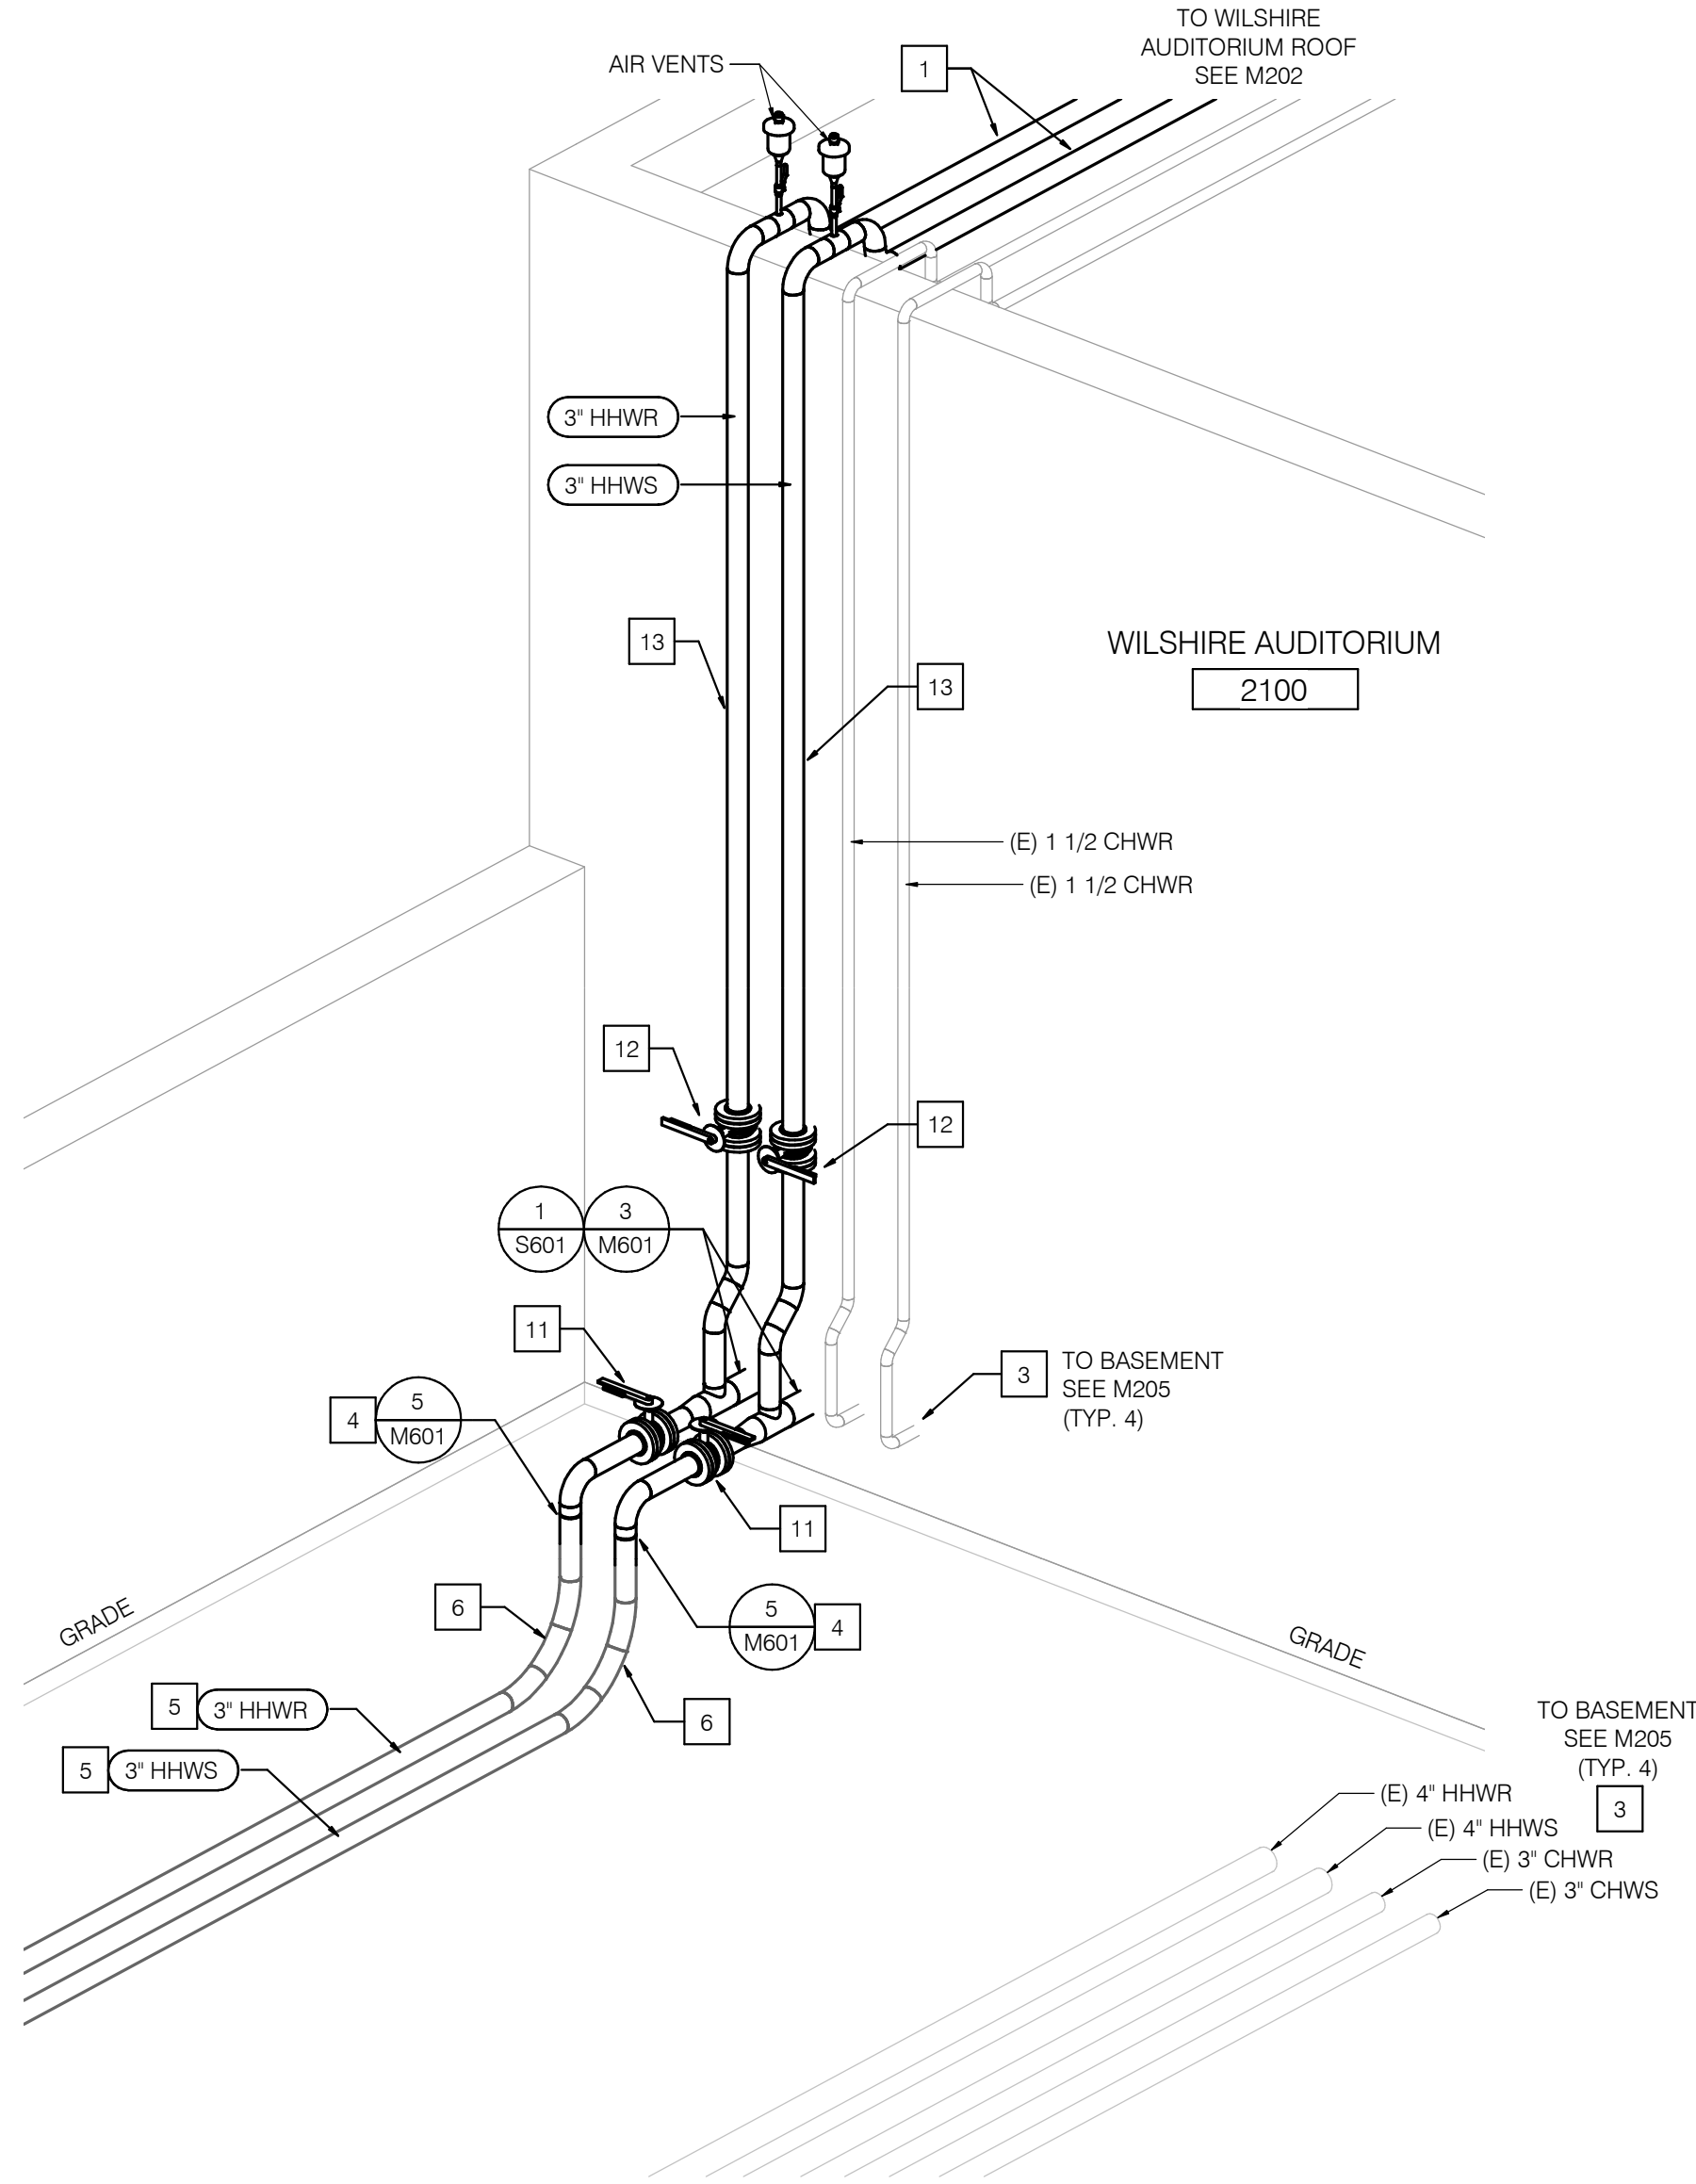
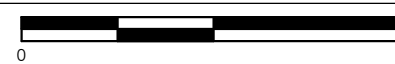
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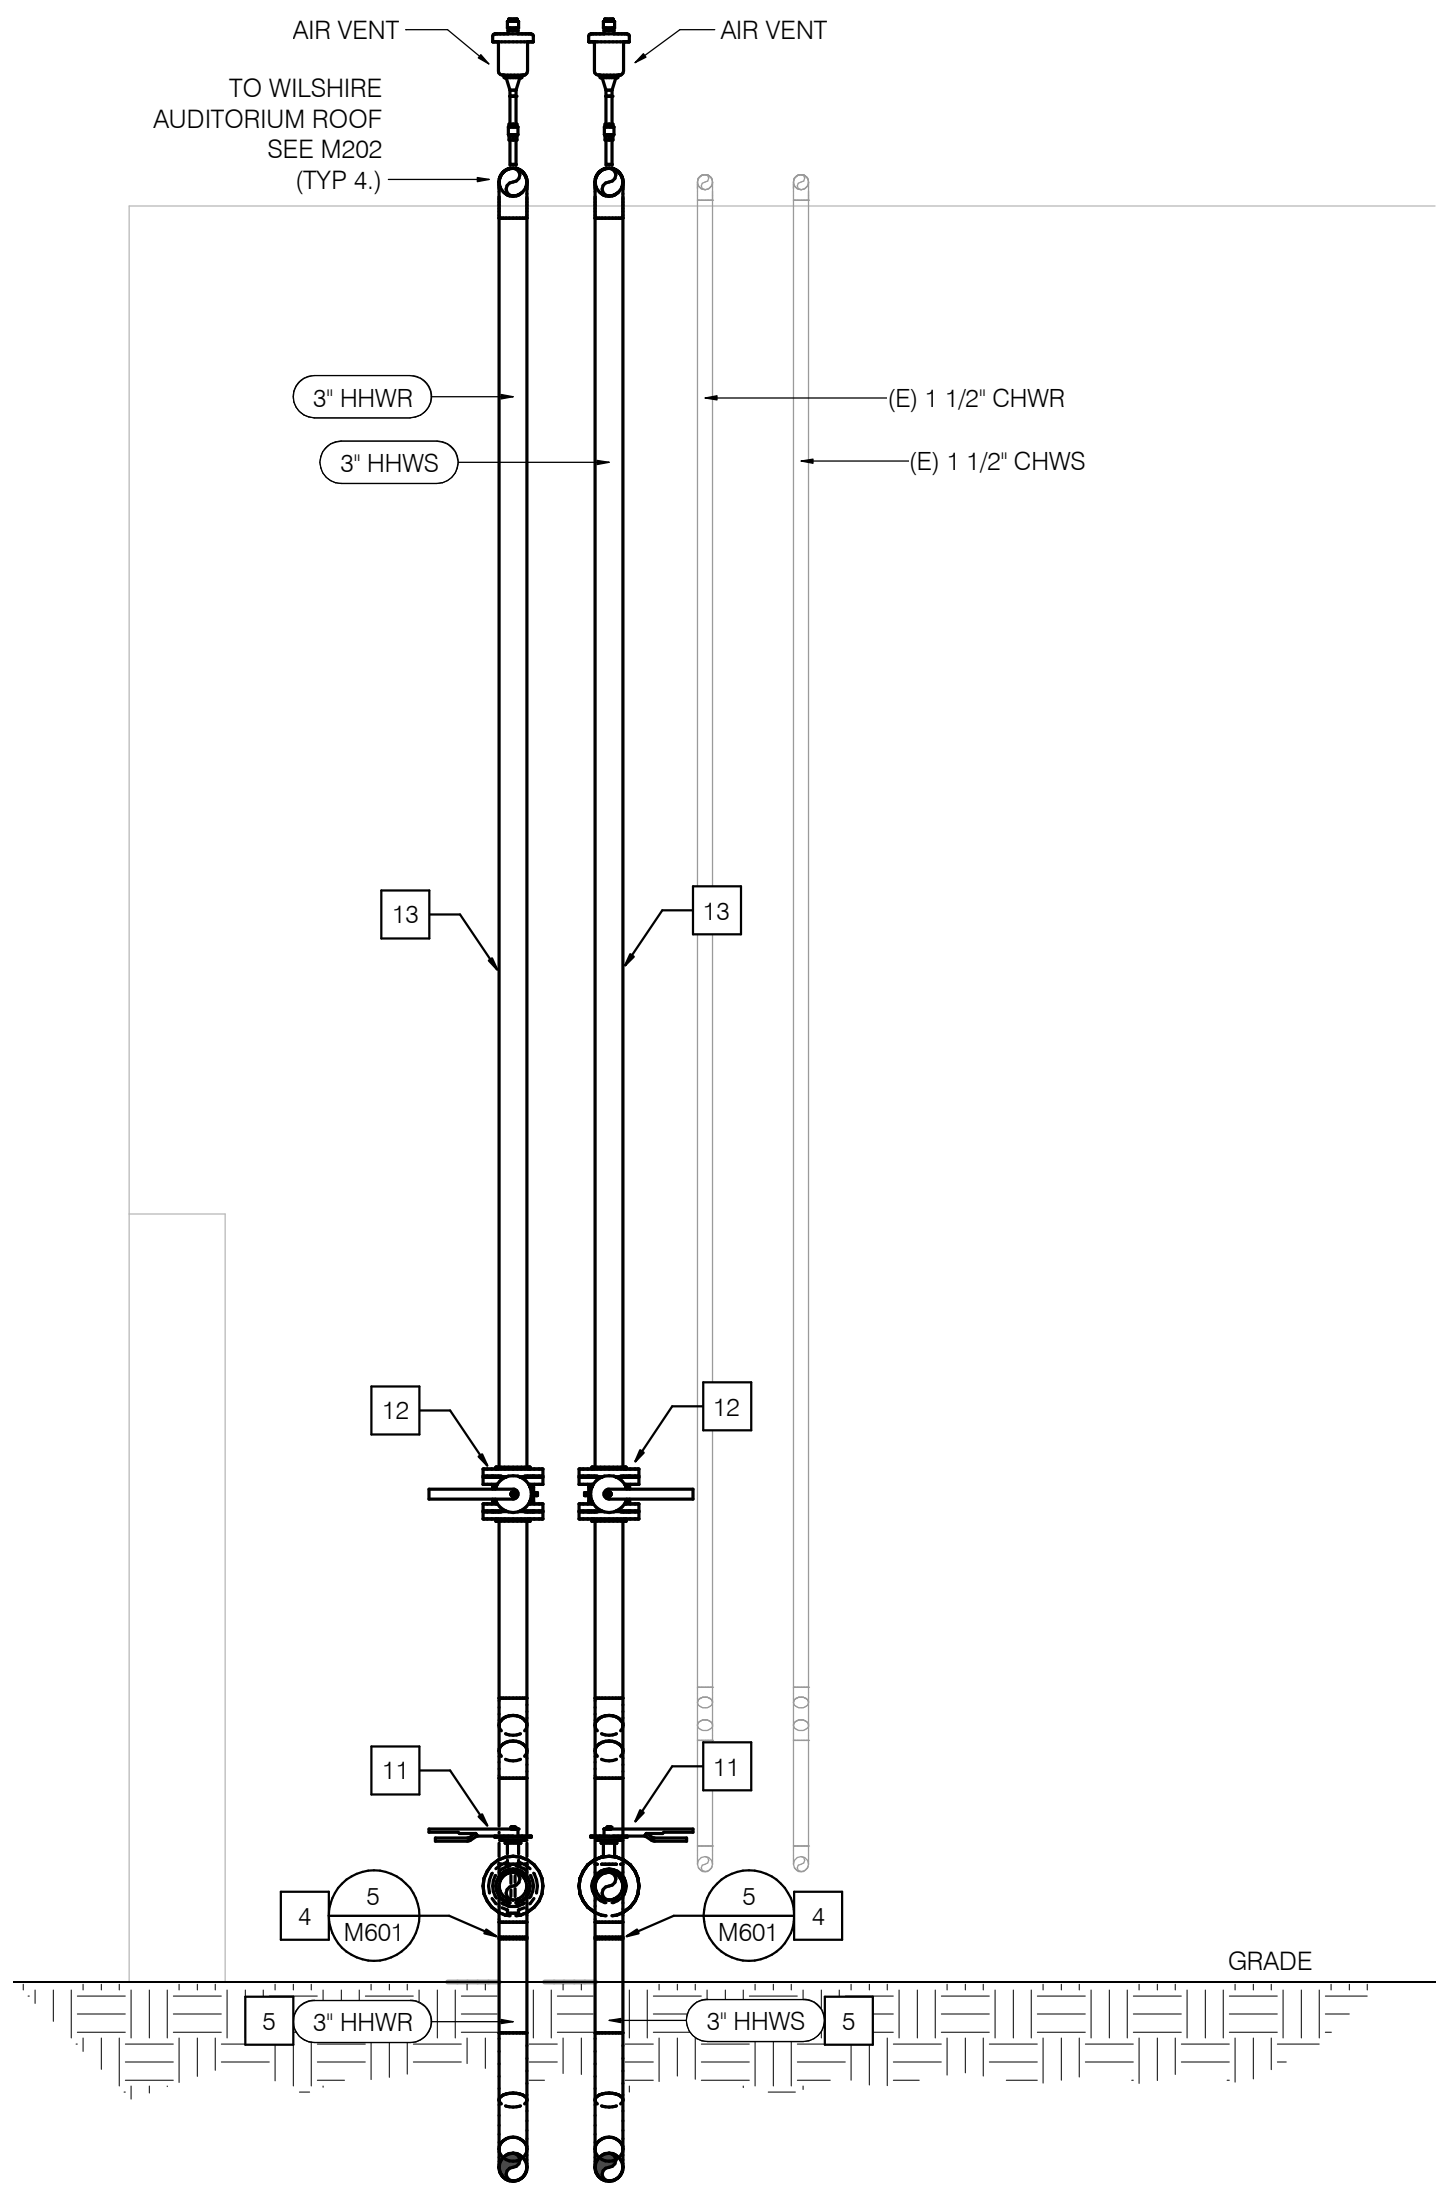
4 BUILDING 2100 CONNECTION - WEST SECTION

SCALE: 1/2" = 1'-0"





5 BUILDING 2100 CONNECTION PLAN ISOMETRIC

SCALE: NONE






3 BUILDING 2100 CONNECTION - NORTH SECTION

SCALE: 1/2" = 1'-0"

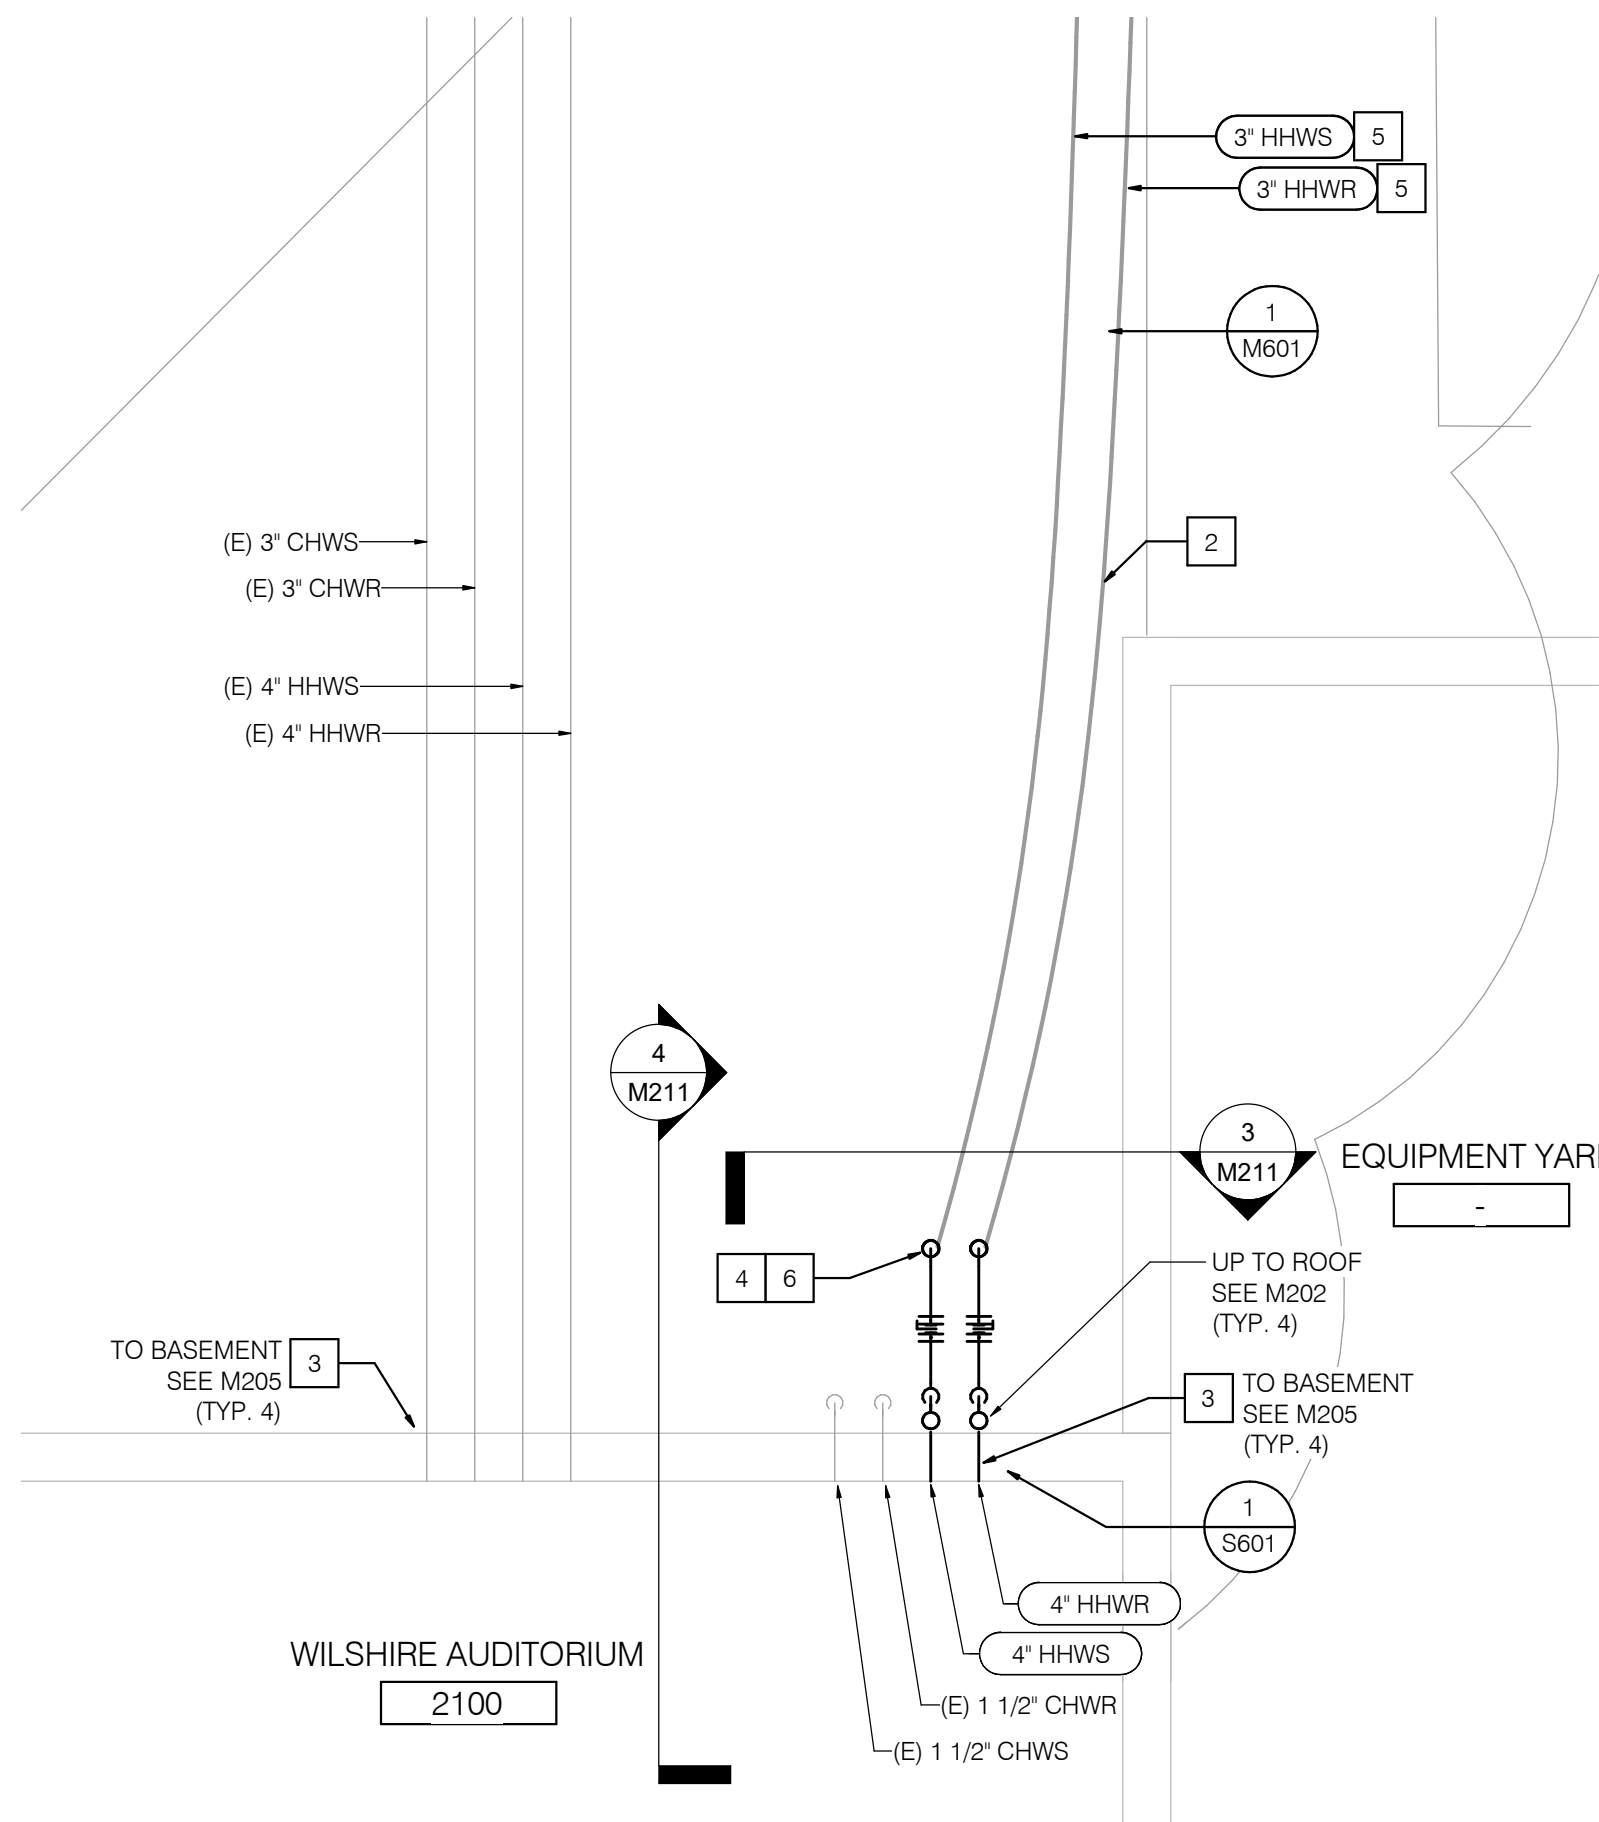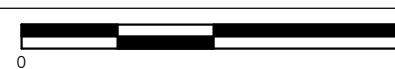



2 BUILDING 2100 CONNECTION PLAN - GROUND LEVEL

SCALE: 1/4" = 1'-0"

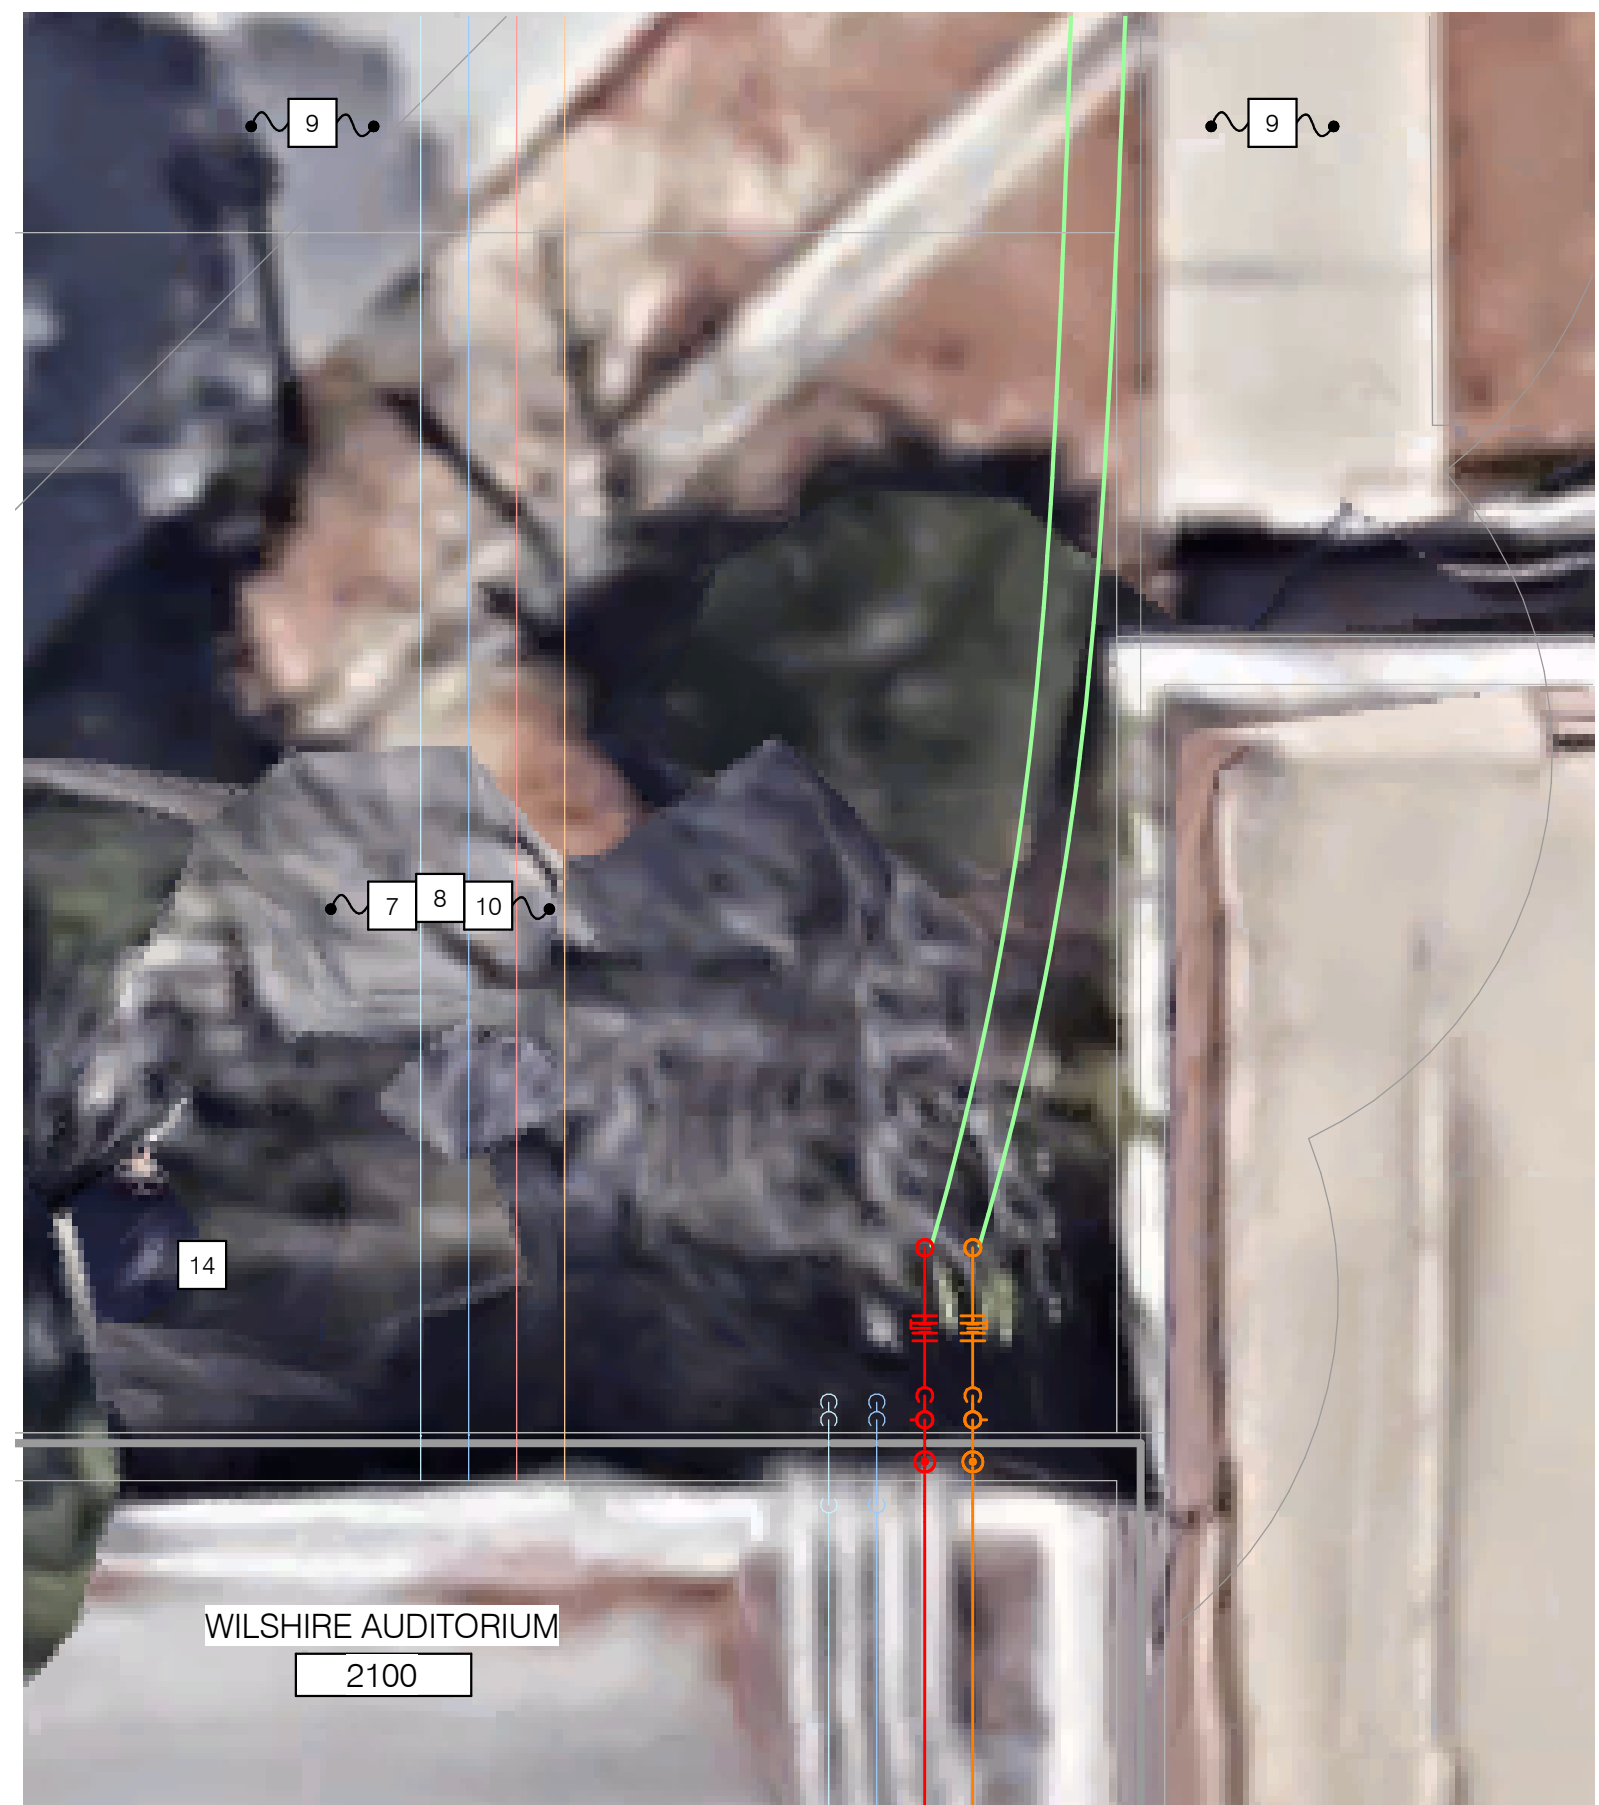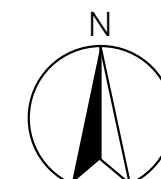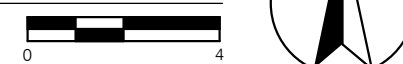


1 BUILDING 2100 SURFACE FEATURE PLAN

SCALE: 1/4" = 1'-0"

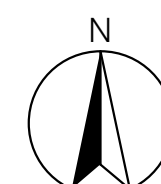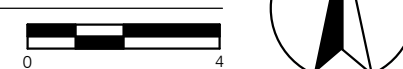

NOTES

- 1 PROVIDE ROOF MOUNTED STEEL PIPING AS SHOWN.
- 2 PROVIDE PREINSULATED DIRECT BURIED PEX PIPING AS SHOWN. PROVIDE ROUTING AS SHOWN TO FOLLOW PLAN AND ELEVATION ROUTING ALONGSIDE EXISTING CHW PIPES. AUTOMATIC AIR VENTS SHALL BE PROVIDED FOR ALL DIRECT BURIED PEX PIPING INSTALLATIONS AT ALL HIGH POINTS. SEE DETAIL 2/M602.
- 3 EXISTING PIPES PENETRATE EXTERIOR WALL AND CONTINUE INTO WILSHIRE AUDITORIUM BASEMENT STORAGE ROOM. FOR CONTINUATION, SEE M205. EXPAND CORES IN CONCRETE WALL TO ACCOMMODATE LARGER HHWS/R PIPE. SEE 1/S601 FOR STRUCTURAL ELEVATION.
- 4 TRANSITION HHWS/R PIPE FROM STEEL TO PEX PRIOR TO PIPE PENETRATION INTO THE GROUND. SEE DETAIL 5/M601.
- 5 PEX PIPE ROUTING SHOWN ON PLANS IS APPROXIMATE. PEX IS A FLEXIBLE PIPE AND ACTUAL ROUTING SHALL BE DETERMINED IN FIELD. CONTRACTOR SHALL SUBMIT PROPOSED ROUTING TO ICR AND CAMPUS FOR APPROVAL. PIPE SHALL BE BURIED AT A MINIMUM OF 3 FEET DEEP. AIR VENTS SHALL BE INSTALLED AT ALL HIGH POINTS PER DETAIL 2/M602.
- 6 PEX PIPING ELBOWS TO BE LAID AT NO MORE THAN A MINIMUM BEND RADIUS OF 4.0 FEET.
- 7 ALL IRRIGATION REMOVED OR DAMAGED DURING CONSTRUCTION SHALL BE REPLACED OR REPAIRED USING CAMPUS STANDARD IRRIGATION STANDARDS.
- 8 ALL LANDSCAPING IMPACTED BY UTILITY WORK WILL BE REPLACED IN KIND. IT IS THE RESPONSIBILITY OF THE CONTRACTOR TO COORDINATE WITH THE CAMPUS STAFF ON EXISTING PLANT, SHRUB, AND TURN TYPE.
- 9 ALL HARDSCAPING FOR SIDEWALKS, PARKING LOTS, AND CURBS WHICH ARE IMPACTED BY UTILITY WORK WILL BE REPLACED IN KIND.
- 10 ALL EXISTING PLANTING NOT IMPACTED BY UTILITY WORK TO BE MAINTAINED IN GOOD GROWING CONDITION. CONTRACTOR SHALL MAINTAIN IRRIGATION TO REMAINING PLANTING DURING THE ENTIRE COURSE OF CONSTRUCTION.
- 11 PROVIDE 3 INCH BUTTERFLY VALVE FOR ISOLATION OF THE NORTH HHW LOOP.
- 12 PROVIDE 3 INCH BUTTERFLY VALVE FOR ISOLATION OF THE SOUTH HHW LOOP. MAX HEIGHT OF 4 FEET ABOVE GRADE.
- 13 SEE STRUCTURAL DETAIL 8/S601 FOR PIPE SUPPORT AT CONCRETE WALL.
- 14 EXISTING TREE SHALL BE PROTECTED IN PLACE.

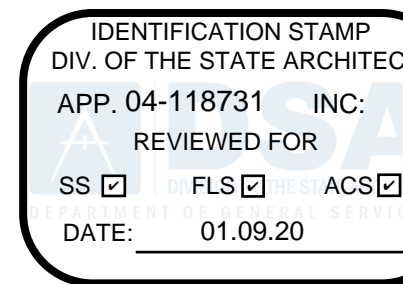

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Project Title

Heating Hot Water
Replacement Parking Lot 10

Owner



321 East Chapman Avenue
Fullerton, CA 92832



Revisions

Number	Description	Date
1	DSA Submittal	10/29/2019
2	DSA Back Check	1/8/2020

Designed T Mueller
Drawn T Mueller
Checked C Dean
Approved M Phillips

Date January 8, 2020

Submittal DSA Back Check

Scale As Noted


Sheet Title
Connection Plan Building
2100

Sheet Number



M211



2 BUILDING 2001/2000 CONNECTION PLAN
SCALE: 1/4" = 1'-0"

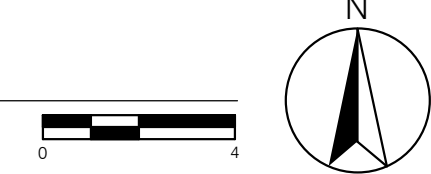


3 BUILDING 2001/2000 SURFACE FEATURE PLAN
SCALE: 1/4" = 1'-0"

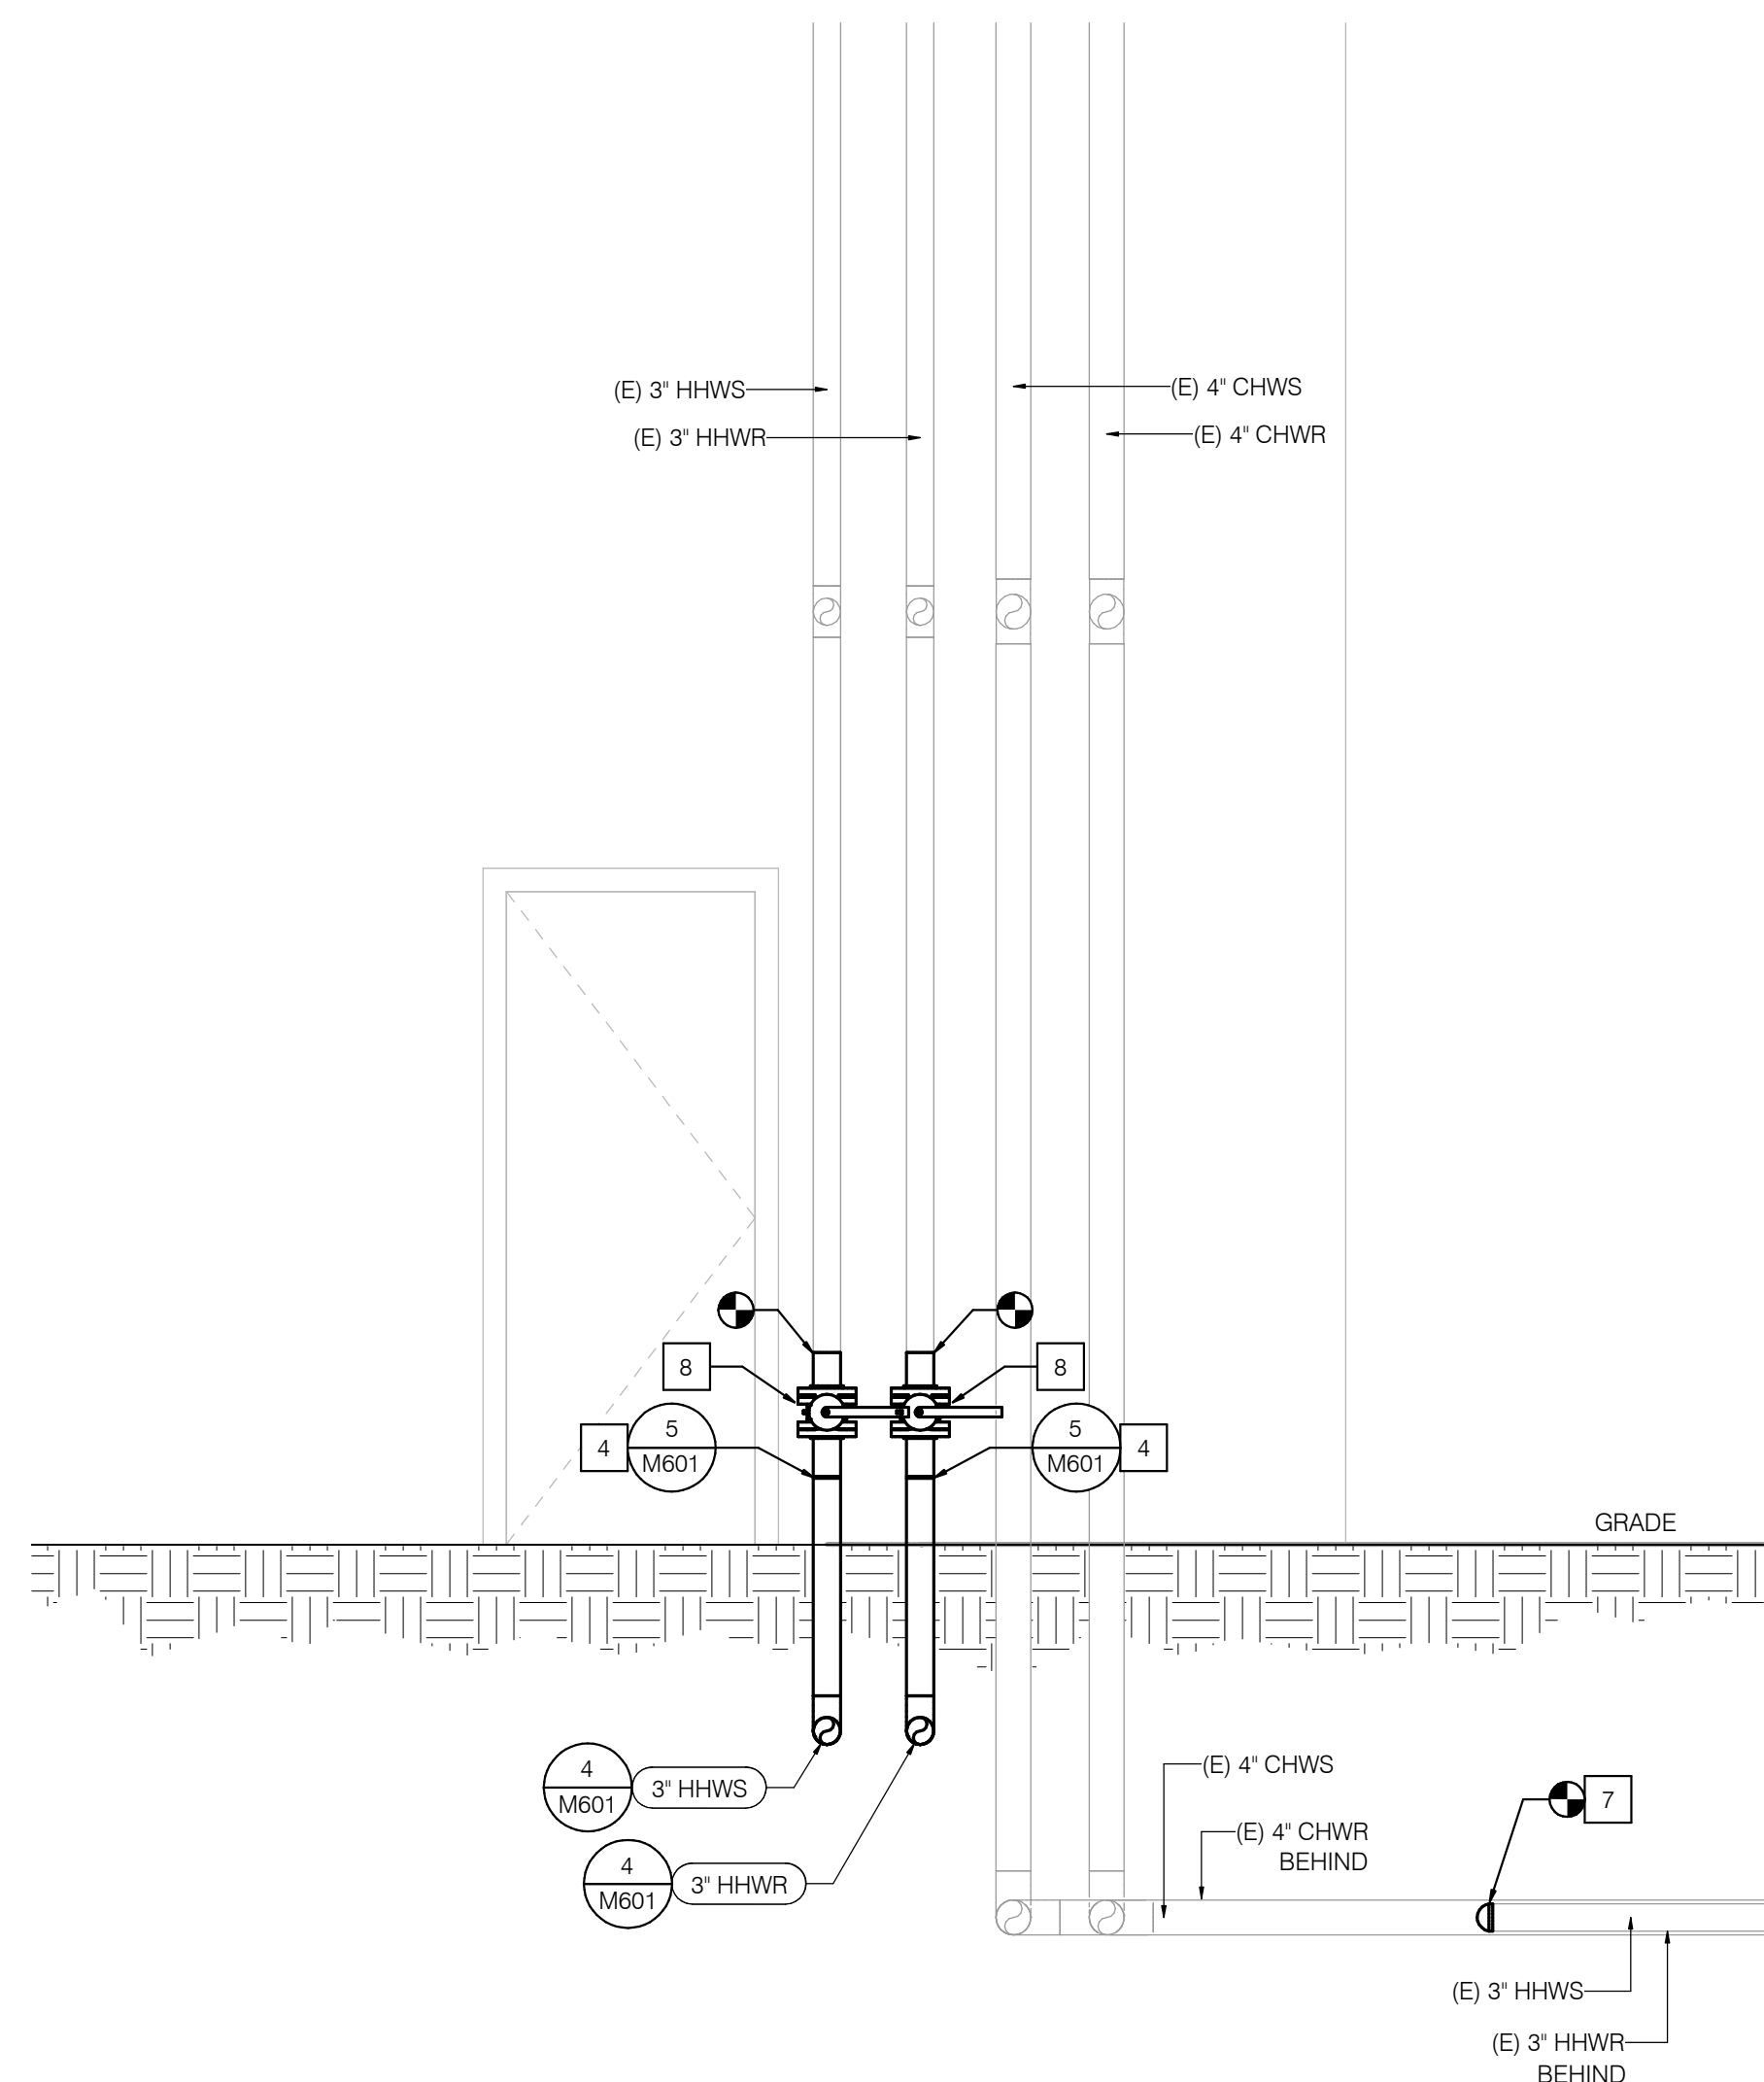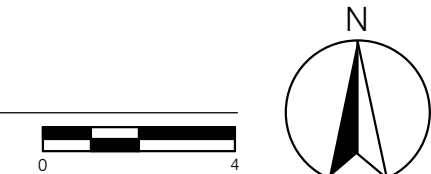

1 BUILDING 2001/2000 - EAST CONNECTION
SCALE: 1/2" = 1'-0"

- GENERAL NOTES**
1. AUTOMATIC AIR VENTS SHALL BE PROVIDED FOR ALL DIRECT BURIED PEX PIPING INSTALLATIONS AT ALL HIGH POINTS. SEE DETAIL 2/M602.
- NOTES**
- 1 PROVIDE PREINSULATED DIRECT BURIED PEX PIPING AS SHOWN. PROVIDE ROUTING AS SHOWN TO FOLLOW FLAN AND ELEVATION ROUTING ALONGSIDE EXISTING CHW PIPES.
 - 2 PEX PIPING ELBOWS TO BE LAID AT NO MORE THAN A MINIMUM BEND RADIUS OF 4.0 FEET.
 - 3 PEX PIPE ROUTING SHOWN ON PLANS IS APPROXIMATE. PEX IS A FLEXIBLE PIPE AND ACTUAL ROUTING SHALL BE DETERMINED IN FIELD. CONTRACTOR SHALL SUBMIT PROPOSED ROUTING TO IOR AND UNIVERSITY FOR APPROVAL. PIPE SHALL BE BURIED AT A MINIMUM OF 3 FEET DEEP.
 - 4 CONNECT 3" HHWS/R PEX PIPE TO EXISTING 3" HHWS/R STEEL PIPE ABOVE GRADE. SEE DETAIL 5/M601.
 - 5 DIRECT BURIED CONNECTION. CONNECT 2" HHWS/R PEX PIPE TO EXISTING 2" HHWS/R STEEL PIPE SEE DETAIL 5/M601.
 - 6 ALL HARDSCAPING FOR SIDEWALKS, PARKING LOTS, AND CURBS WHICH ARE IMPACTED BY UTILITY WORK WILL BE REPLACED IN KIND. SEE M301 FOR PAVING FINISH INFORMATION.
 - 7 CAP (E) HHWS/R PIPES AND ABANDON IN PLACE. REFER TO PIPE SIZES INDICATED ON THE PLANS.
 - 8 PROVIDE 3 INCH BUTTERFLY VALVE ON STEEL SEGMENT BETWEEN PEX PIPING TRANSITION AND STEEL POINT OF CONNECTION FOR THE ISOLATION OF BUILDING 2001/2000 EAST WING.
 - 9 EXISTING SHUTOFF VALVES FOR BUILDING 2001/2000 WEST WING LOCATED ON EXISTING RISERS IN STORAGE ROOM.
 - 10 EXISTING TREE SHALL BE PROTECTED IN PLACE.

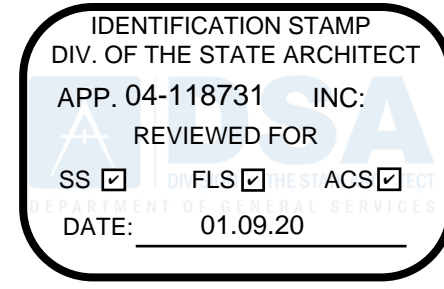

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Project Title
**Heating Hot Water
Replacement Parking Lot 10**

Owner



321 East Chapman Avenue
Fullerton, CA 92832



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1	DSA Submittal	10/29/2019
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Designed T Mueller
Drawn T Mueller
Checked C Dean
Approved M Phillips

Date January 8, 2020


Submittal DSA Back Check

Scale As Noted

Sheet Title
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2001/2000**


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M212

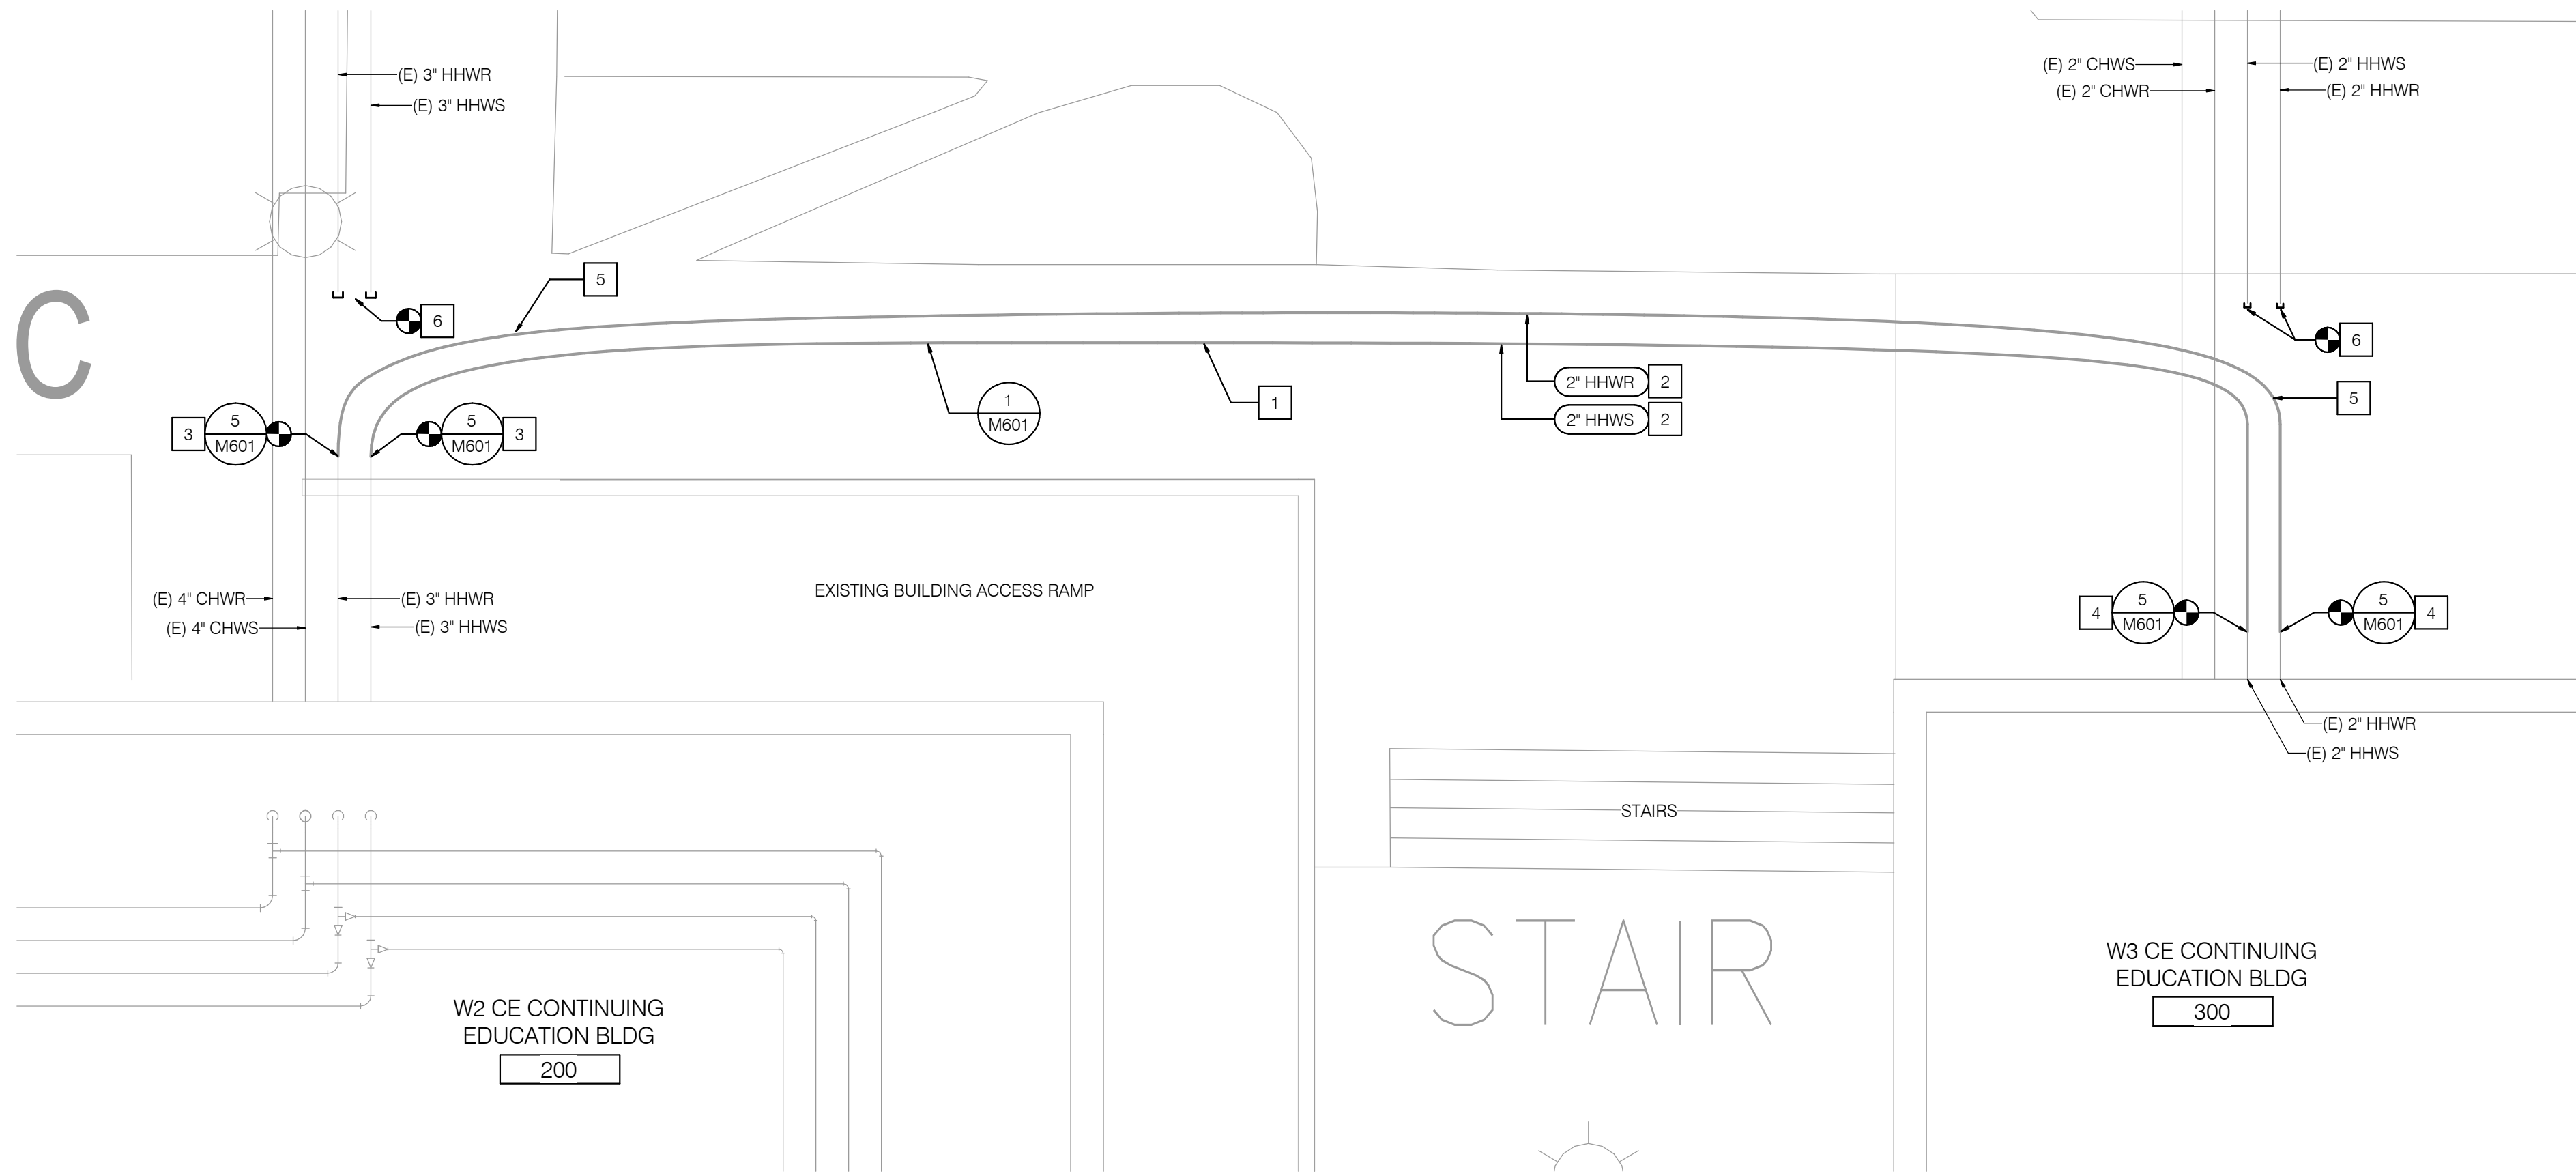


2 BUILDING 200 AND BUILDING 300 CONNECTION PLAN

SCALE: 1/4" = 1'-0"

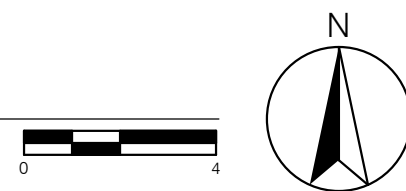

1 BUILDING 200 AND BUILDING 300 SURFACE FEATURE PLAN

SCALE: 1/4" = 1'-0"

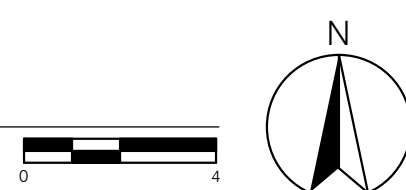


GENERAL NOTES

1. AUTOMATIC AIR VENTS SHALL BE PROVIDED FOR ALL DIRECT BURIED PEX PIPING INSTALLATIONS AT ALL HIGH POINTS. SEE DETAIL 2/M602.

NOTES

1. PROVIDE PREINSULATED DIRECT BURIED PEX PIPING AS SHOWN. PROVIDE ROUTING AS SHOWN TO FOLLOW FLAN AND ELEVATION ROUTING ALONGSIDE EXISTING CHW PIPES. AIR VENTS SHALL BE PROVIDED FOR ALL PEX PIPING INSTALLATIONS AT ALL HIGH POINTS. SEE DETAIL 2/M602.
2. PEX PIPE ROUTING SHOWN ON PLANS IS APPROXIMATE. PEX IS A FLEXIBLE PIPE AND ACTUAL ROUTING SHALL BE DETERMINED IN FIELD. CONTRACTOR SHALL SUBMIT PROPOSED ROUTING TO IOR AND UNIVERSITY FOR APPROVAL. PIPE SHALL BE BURIED AT A MINIMUM OF 3 FEET DEEP. AIR VENTS SHALL BE INSTALLED AT ALL HIGH POINTS PER DETAIL 2/M602.
3. CONNECT AND TRANSITION FROM 2" PEX HHWS/R PIPES TO EXISTING 3" STEEL HHWS/R PIPES. SEE DETAIL 5/M601.
4. CONNECT 2" PEX HHWS/R PIPES TO EXISTING 2" STEEL HHWS/R PIPES. SEE DETAIL 5/M601.
5. PEX PIPING ELBOWS TO BE LAID AT NO MORE THAN A MINIMUM BEND RADIUS OF 4.0 FEET.
6. CAP (E) HHWS/R PIPES AND ABANDON IN PLACE. REFER TO PIPE SIZES INDICATED ON THE PLANS.
7. ALL IRRIGATION REMOVED OR DAMAGED DURING CONSTRUCTION SHALL BE REPLACED OR REPAIRED USING CAMPUS STANDARD IRRIGATION STANDARDS.
8. ALL LANDSCAPING IMPACTED BY UTILITY WORK WILL BE REPLACED IN KIND. IT IS THE RESPONSIBILITY OF THE CONTRACTOR TO COORDINATE WITH THE CAMPUS STAFF ON EXISTING PLANT, SHRUB, AND TURN TYPE.
9. ALL HARDSCAPING FOR SIDEWALKS, PARKING LOTS, AND CURBS WHICH ARE IMPACTED BY UTILITY WORK WILL BE REPLACED IN KIND. SEE M302 FOR PAVING FINISH INFORMATION.
10. ALL EXISTING PLANTING NOT IMPACTED BY UTILITY WORK TO BE MAINTAINED IN GOOD GROWING CONDITION. CONTRACTOR SHALL MAINTAIN IRRIGATION TO REMAINING PLANTING DURING THE ENTIRE COURSE OF CONSTRUCTION.

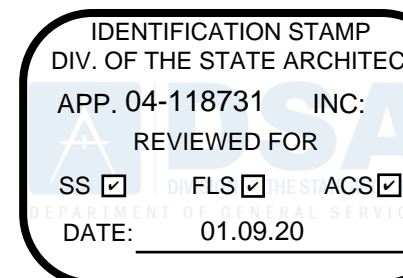

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Project Title

Heating Hot Water
Replacement Parking Lot 10

Owner



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Number	Description	Date
1	DSA Submittal	10/29/2019
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Designed T Mueller
Drawn T Mueller
Checked C Dean
Approved M Phillips

Date January 8, 2020

Submittal DSA Back Check


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Sheet Title
Connection Plan Building
200 and Building 300

Sheet Number

M213

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TRENCHWORK LEGEND

- CONCRETE SIDEWALK
- ASPHALT PARKING LOT
- GRASS LANDSCAPE


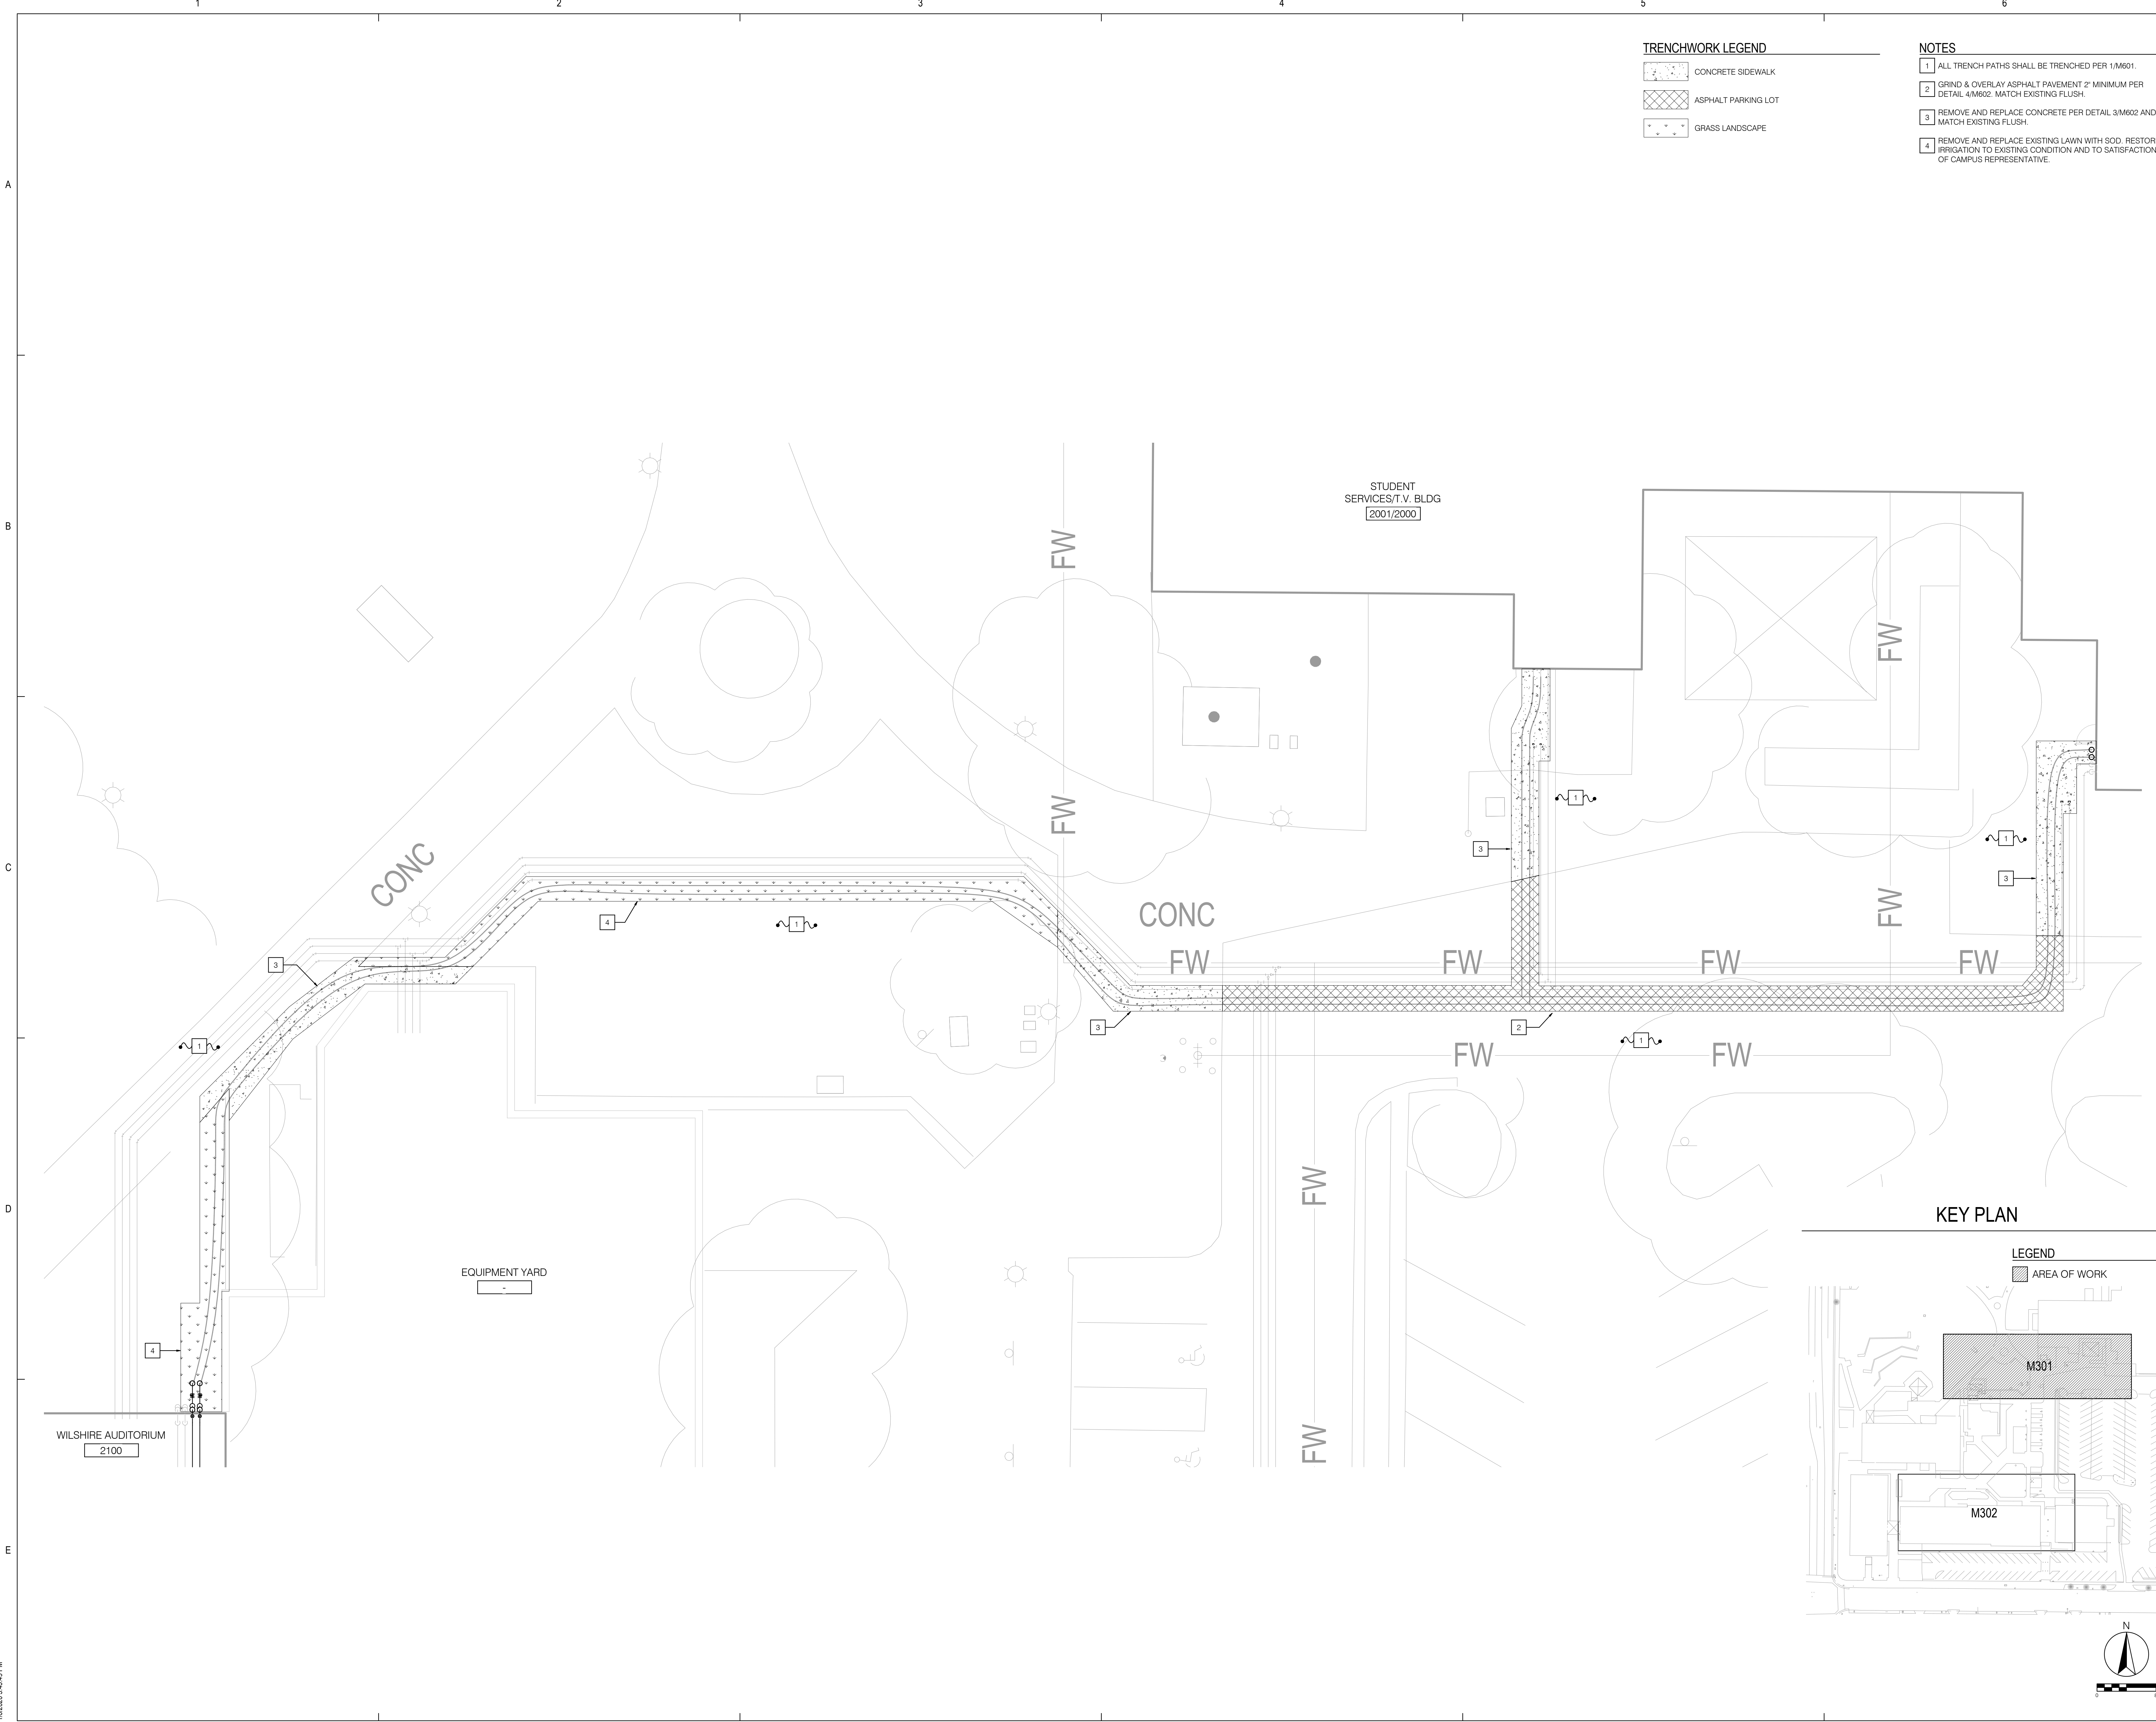
NOTES

- ALL TRENCH PATHS SHALL BE TRENCHED PER 1/M601.
- GRIND & OVERLAY ASPHALT PAVEMENT 2" MINIMUM PER DETAIL 4/M602. MATCH EXISTING FLUSH.
- REMOVE AND REPLACE CONCRETE PER DETAIL 3/M602 AND MATCH EXISTING FLUSH.
- REMOVE AND REPLACE EXISTING LAWN WITH SOD. RESTORE IRRIGATION TO EXISTING CONDITION AND TO SATISFACTION OF CAMPUS REPRESENTATIVE.

KEY PLAN

LEGEND

- AREA OF WORK

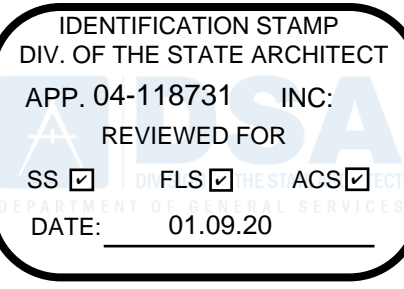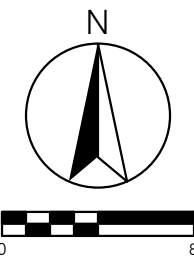

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Project Title
Heating Hot Water
Replacement Parking Lot 10

Owner



321 East Chapman Avenue
Fullerton, CA 92832



Revisions		
Number	Description	Date
1	DSA Submittal	10/29/2019
2	DSA Back Check	1/8/2020

Designed	T Mueller
Drawn	T Mueller
Checked	C Dean
Approved	M Phillips

Date January 8, 2020

Submittal DSA Back Check

Scale 1/8" = 1'-0"


Sheet Title
North Trench Repair and
Paving Plan

Sheet Number

M301

P2S No. 9570

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TRENCHWORK LEGEND

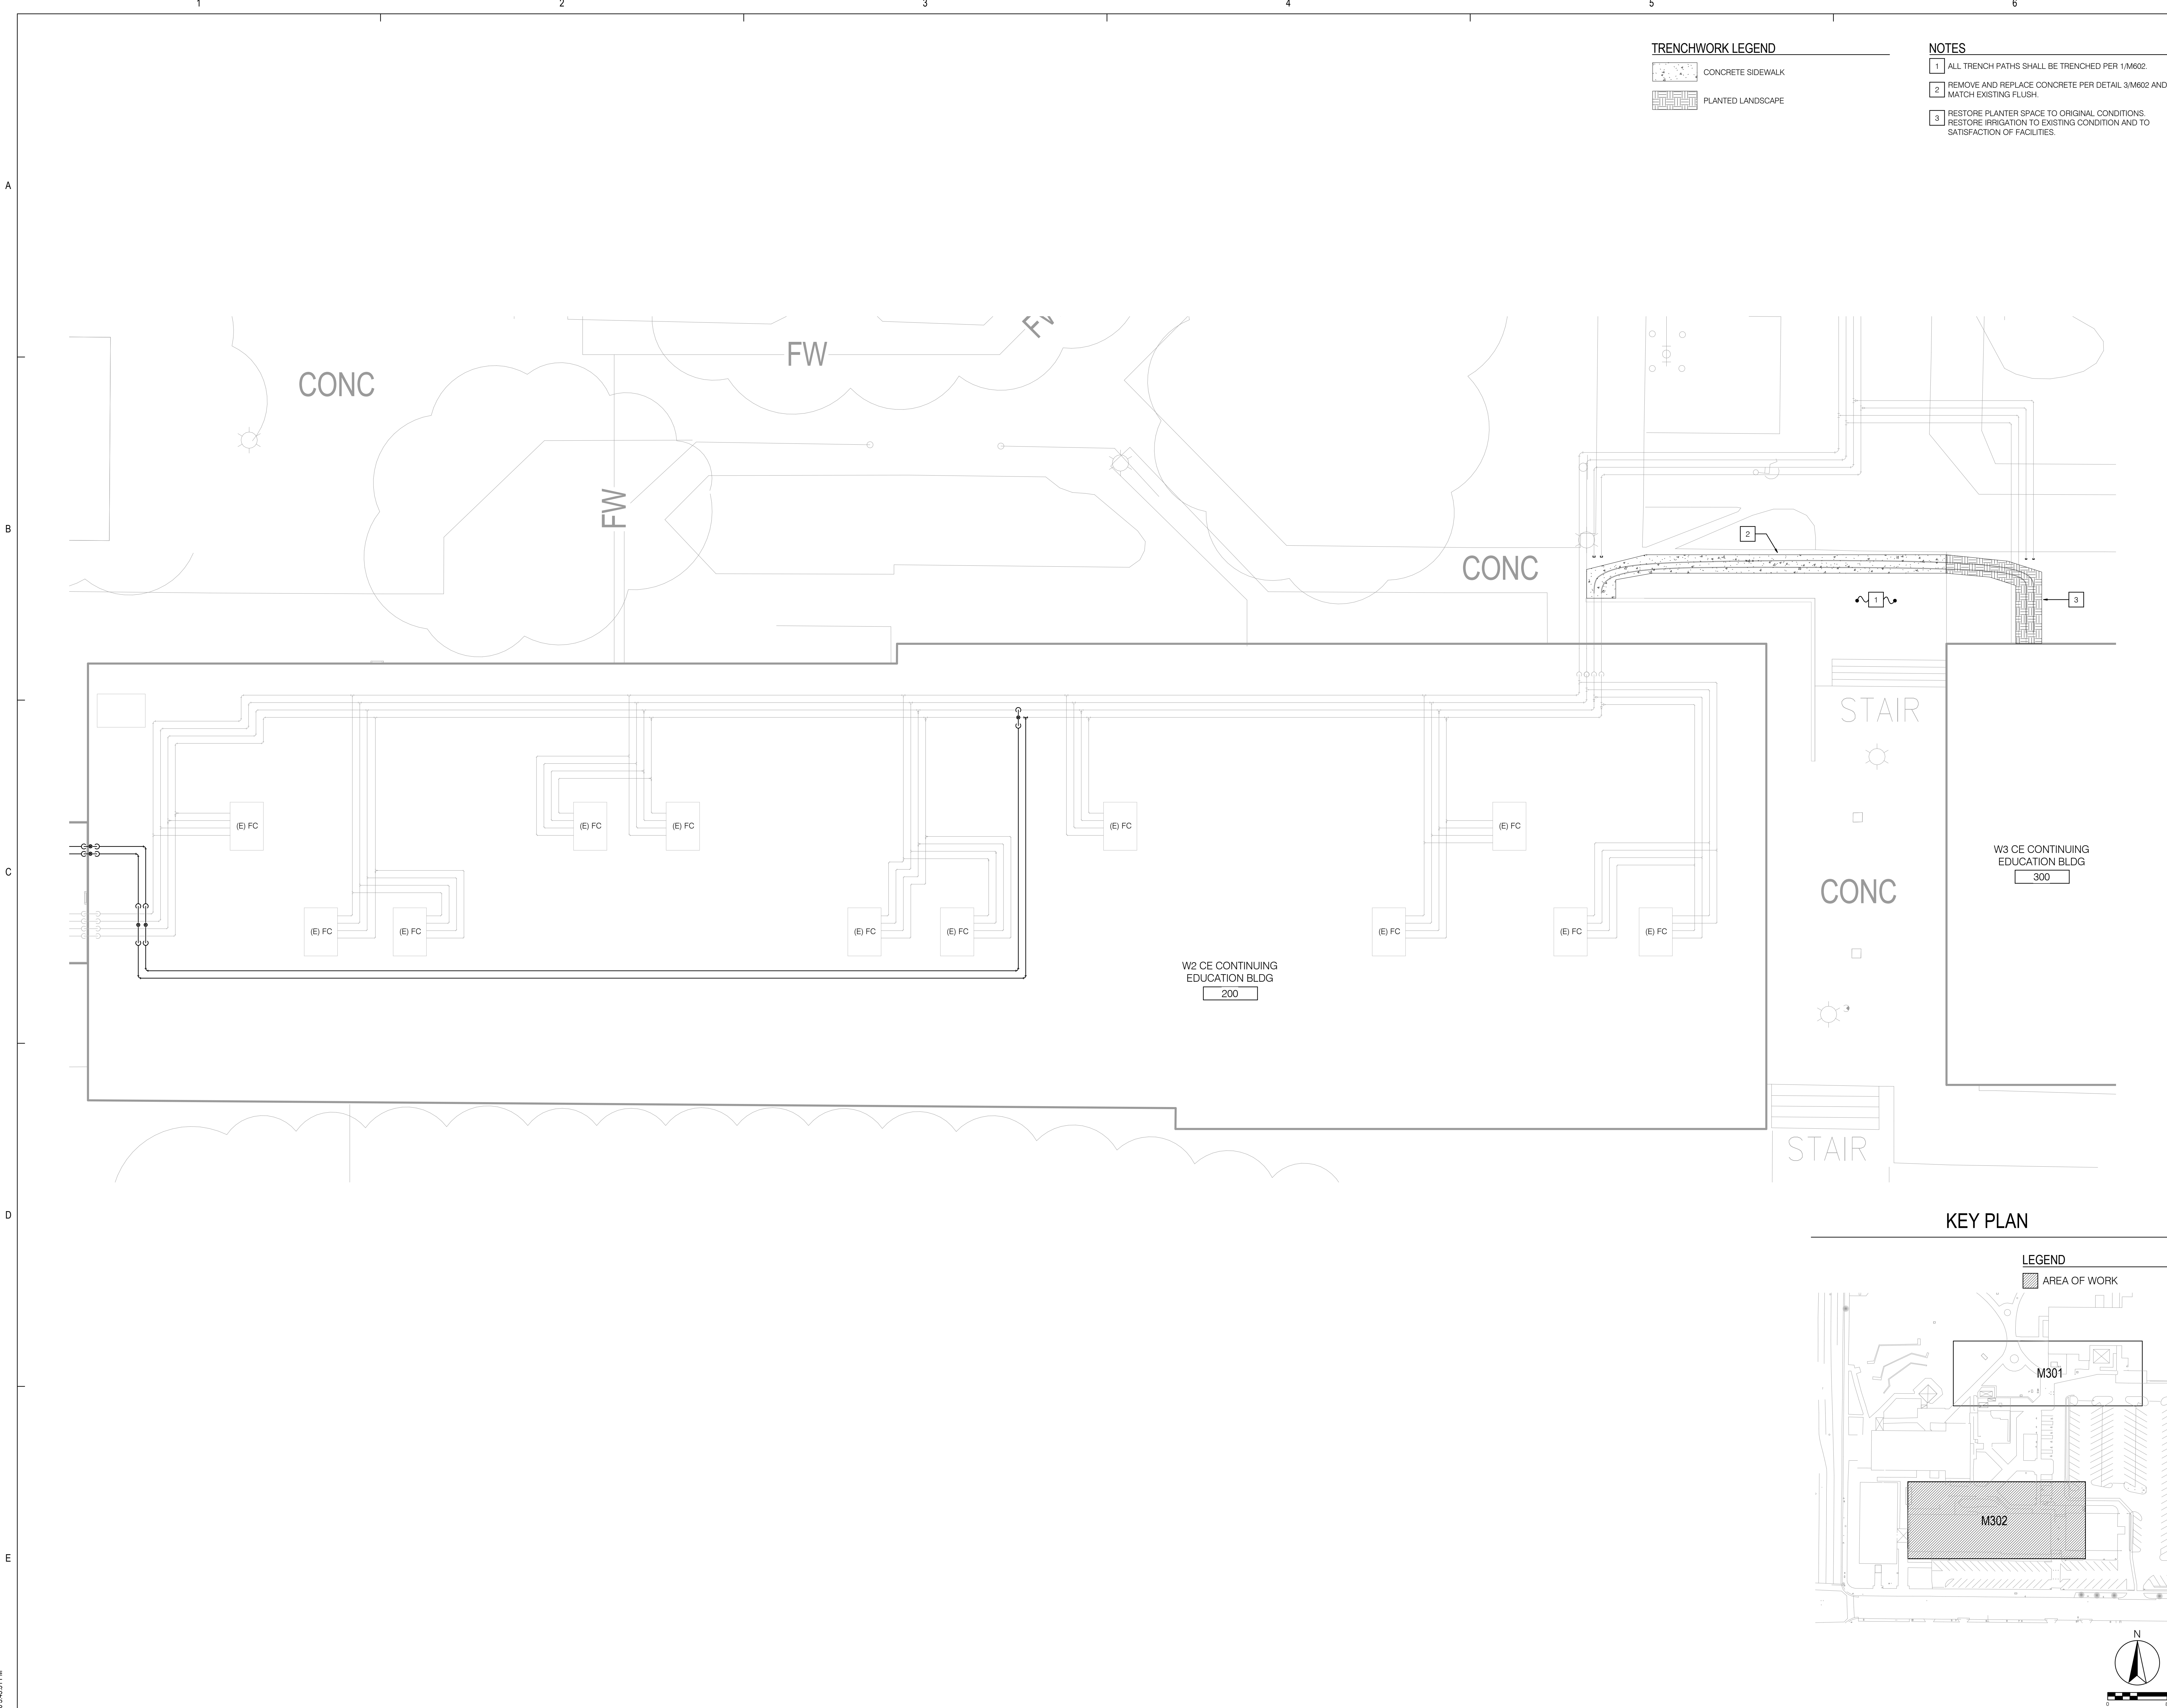- CONCRETE SIDEWALK
- PLANTED LANDSCAPE

NOTES

- 1 ALL TRENCH PATHS SHALL BE TRENCHED PER 1/M602.
- 2 REMOVE AND REPLACE CONCRETE PER DETAIL 3/M602 AND MATCH EXISTING FLUSH.
- 3 RESTORE PLANTER SPACE TO ORIGINAL CONDITIONS. RESTORE IRRIGATION TO EXISTING CONDITION AND TO SATISFACTION OF FACILITIES.

IDENTIFICATION STAMP

DIV. OF THE STATE ARCHITECT

APP. 04-118731 INC.

REVIEWED FOR

SS ☐ FLS ☐ ACS ☐

DATE: 01.09.20



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Project Title
Heating Hot Water
Replacement Parking Lot 10

Owner



321 East Chapman Avenue
Fullerton, CA 92832



Revisions		
Number	Description	Date
1	DSA Submittal	10/29/2019
2	DSA Back Check	1/8/2020

Designed	T Mueller
Drawn	T Mueller
Checked	C Dean
Approved	M Phillips

Date: January 8, 2020

Submittal: DSA Back Check

Scale: 1/8" = 1'-0"

Sheet Title
South Trench Repair and
Paving Plan

Sheet Number

M302

P2S No. 9570

Revisions		
Number	Description	Date
1	DSA Submittal	10/29/2019
2	DSA Back Check	1/8/2020

Designed	T Mueller
Drawn	T Mueller
Checked	C Dean
Approved	M Phillips

Date

January 8, 2020

Submittal

DSA Back Check

Scale


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Sheet Title

Isometric Views


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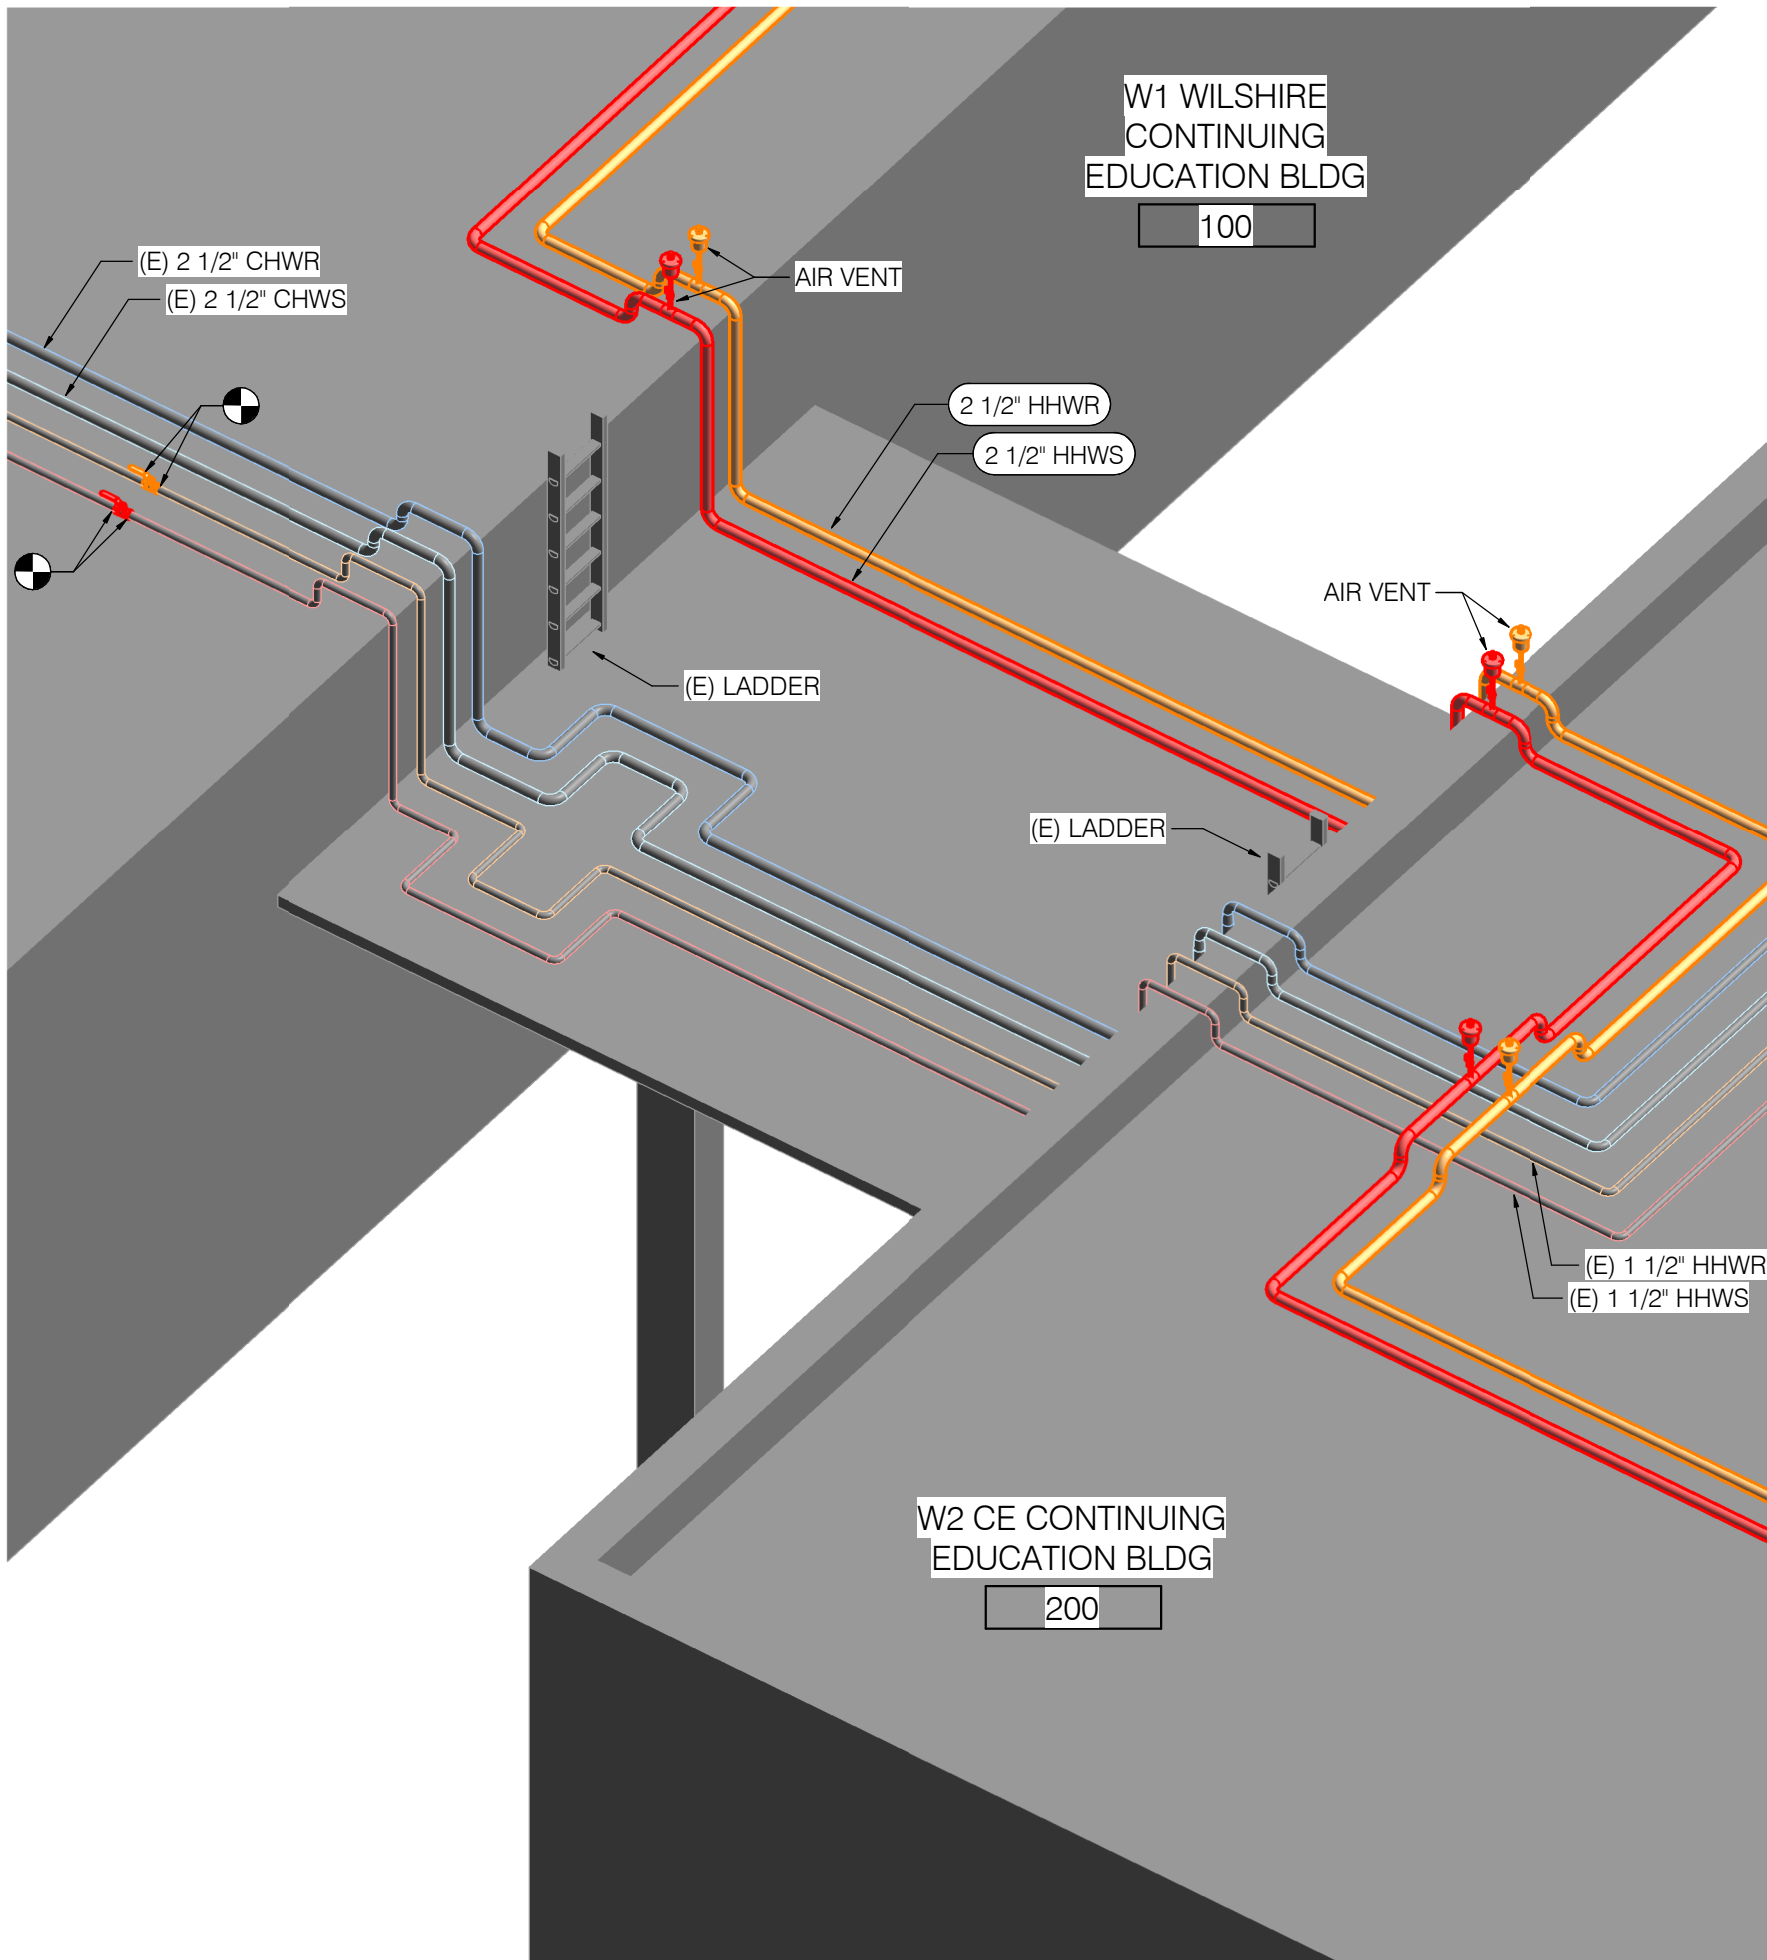
2 PIPE AWNING ISOMETRIC - BUILDING 2100 TO BUILDING 100

SCALE: NONE

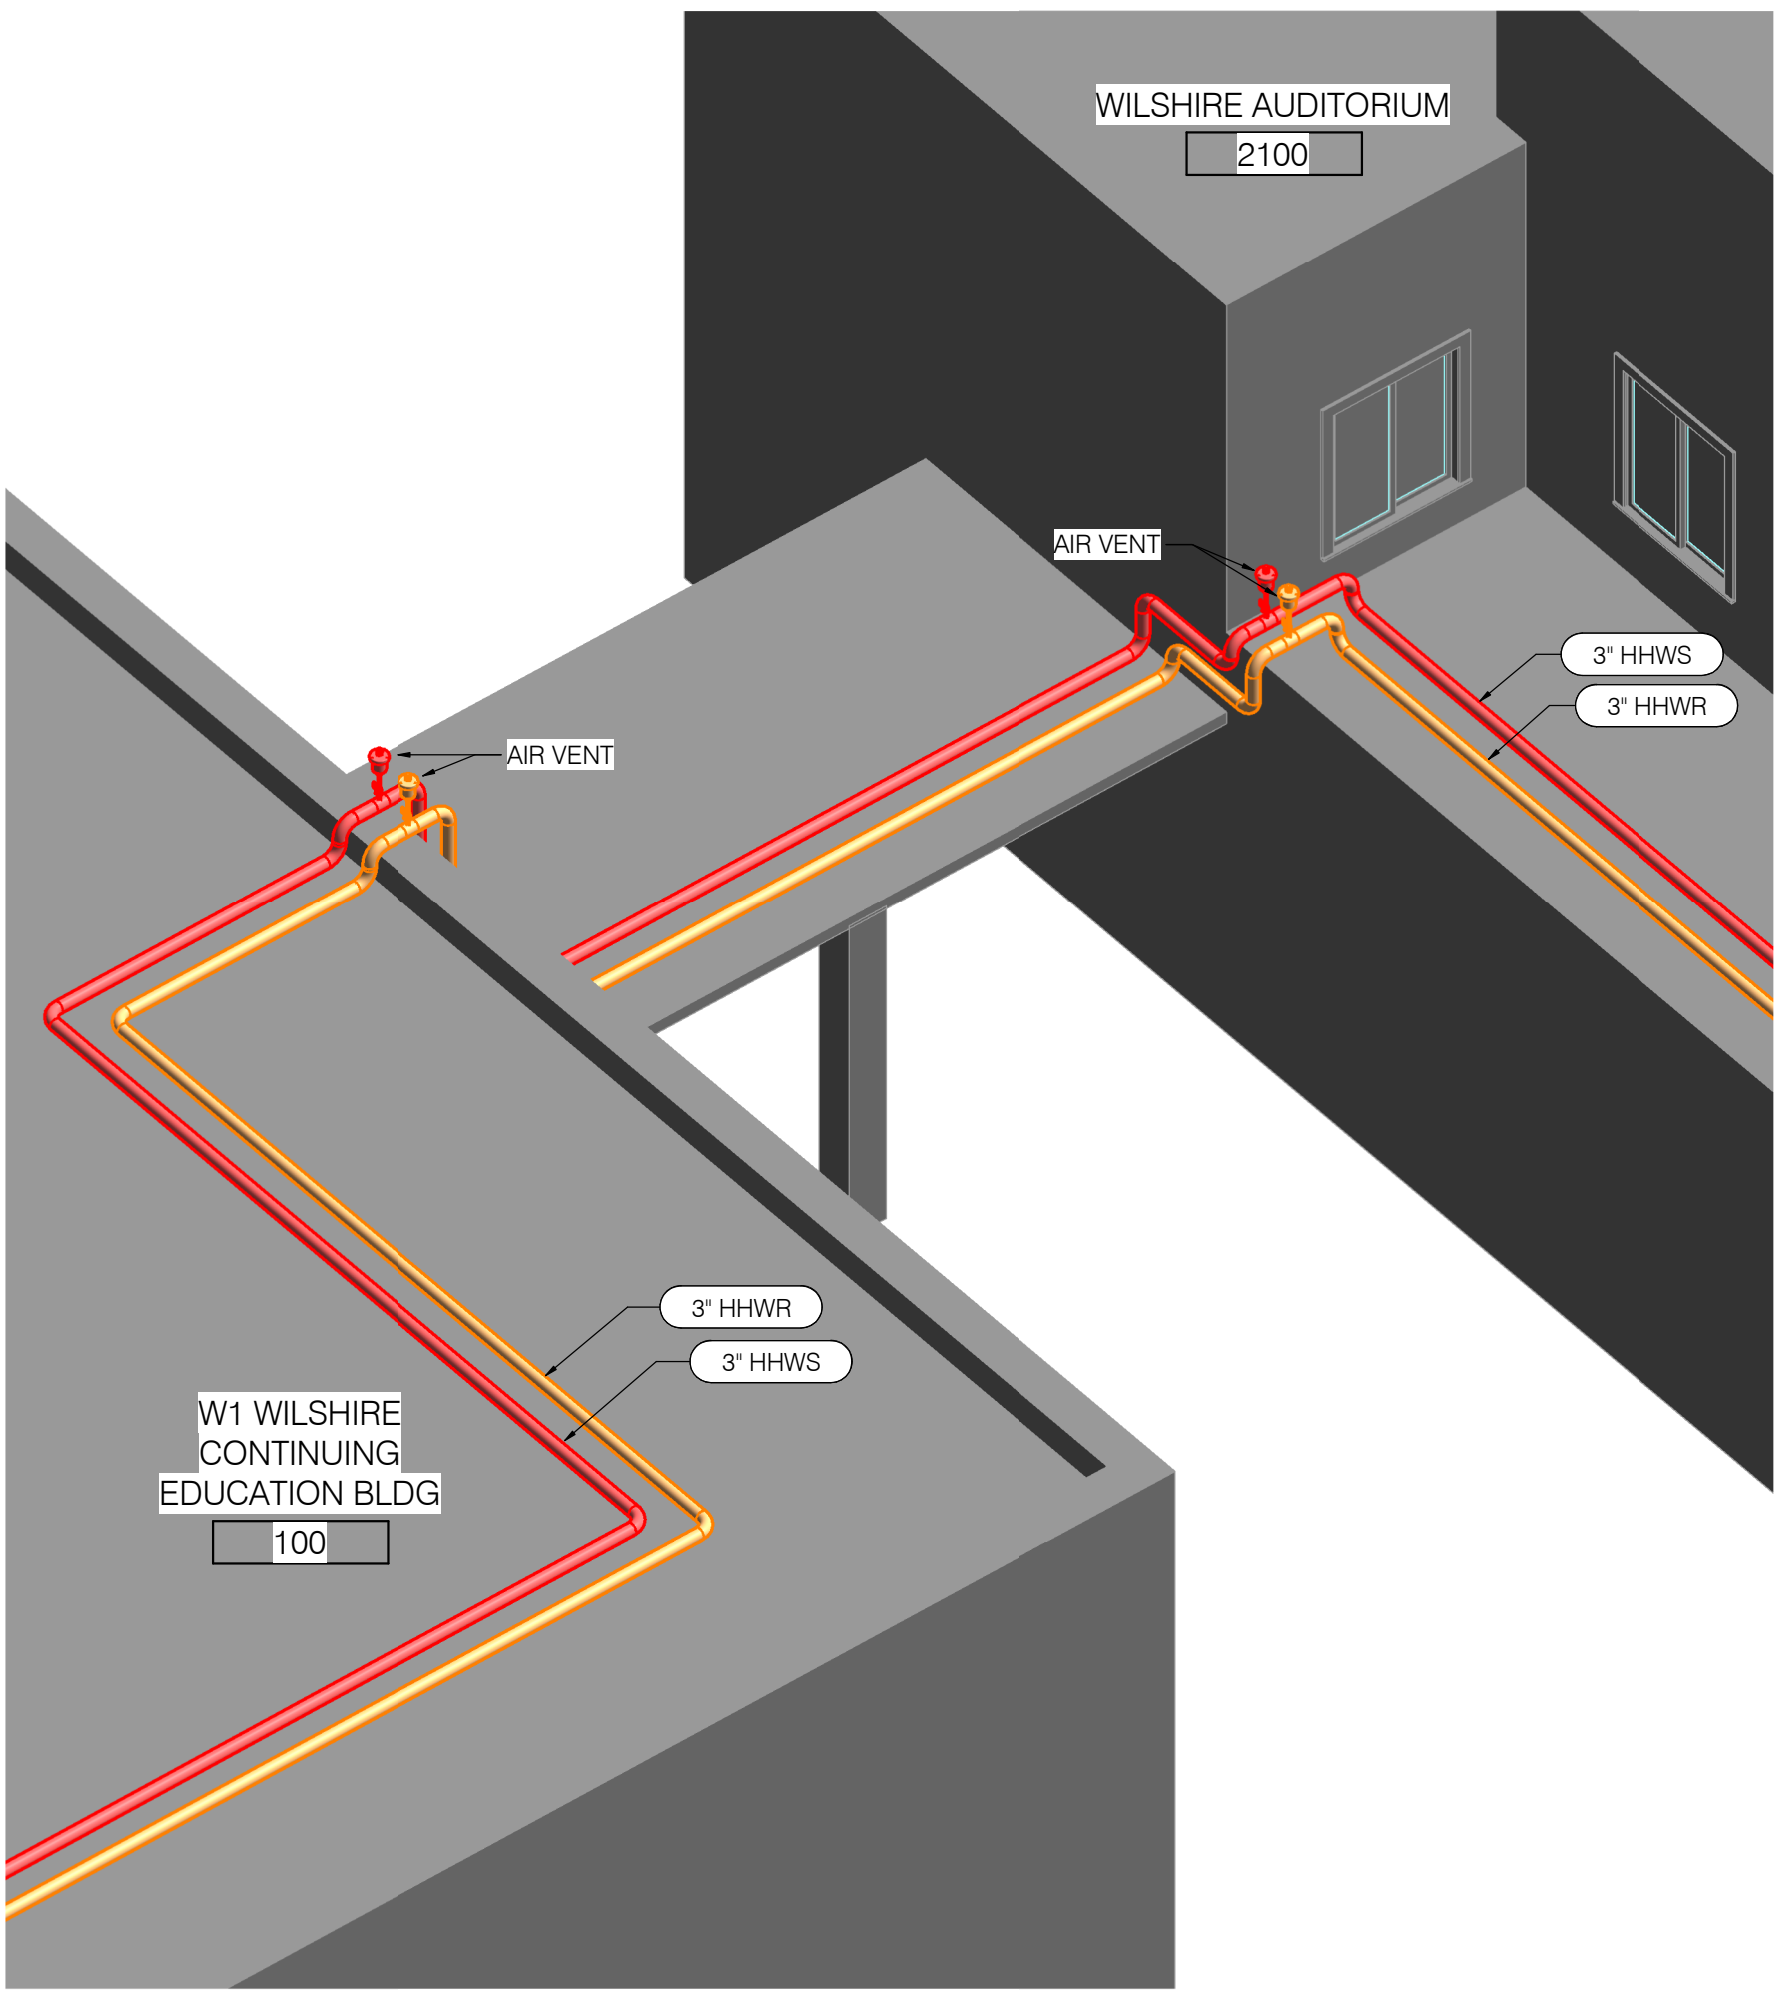

1 PIPE RISER ISOMETRIC - BUILDING 2100 SOUTH ROOF


SCALE: NONE

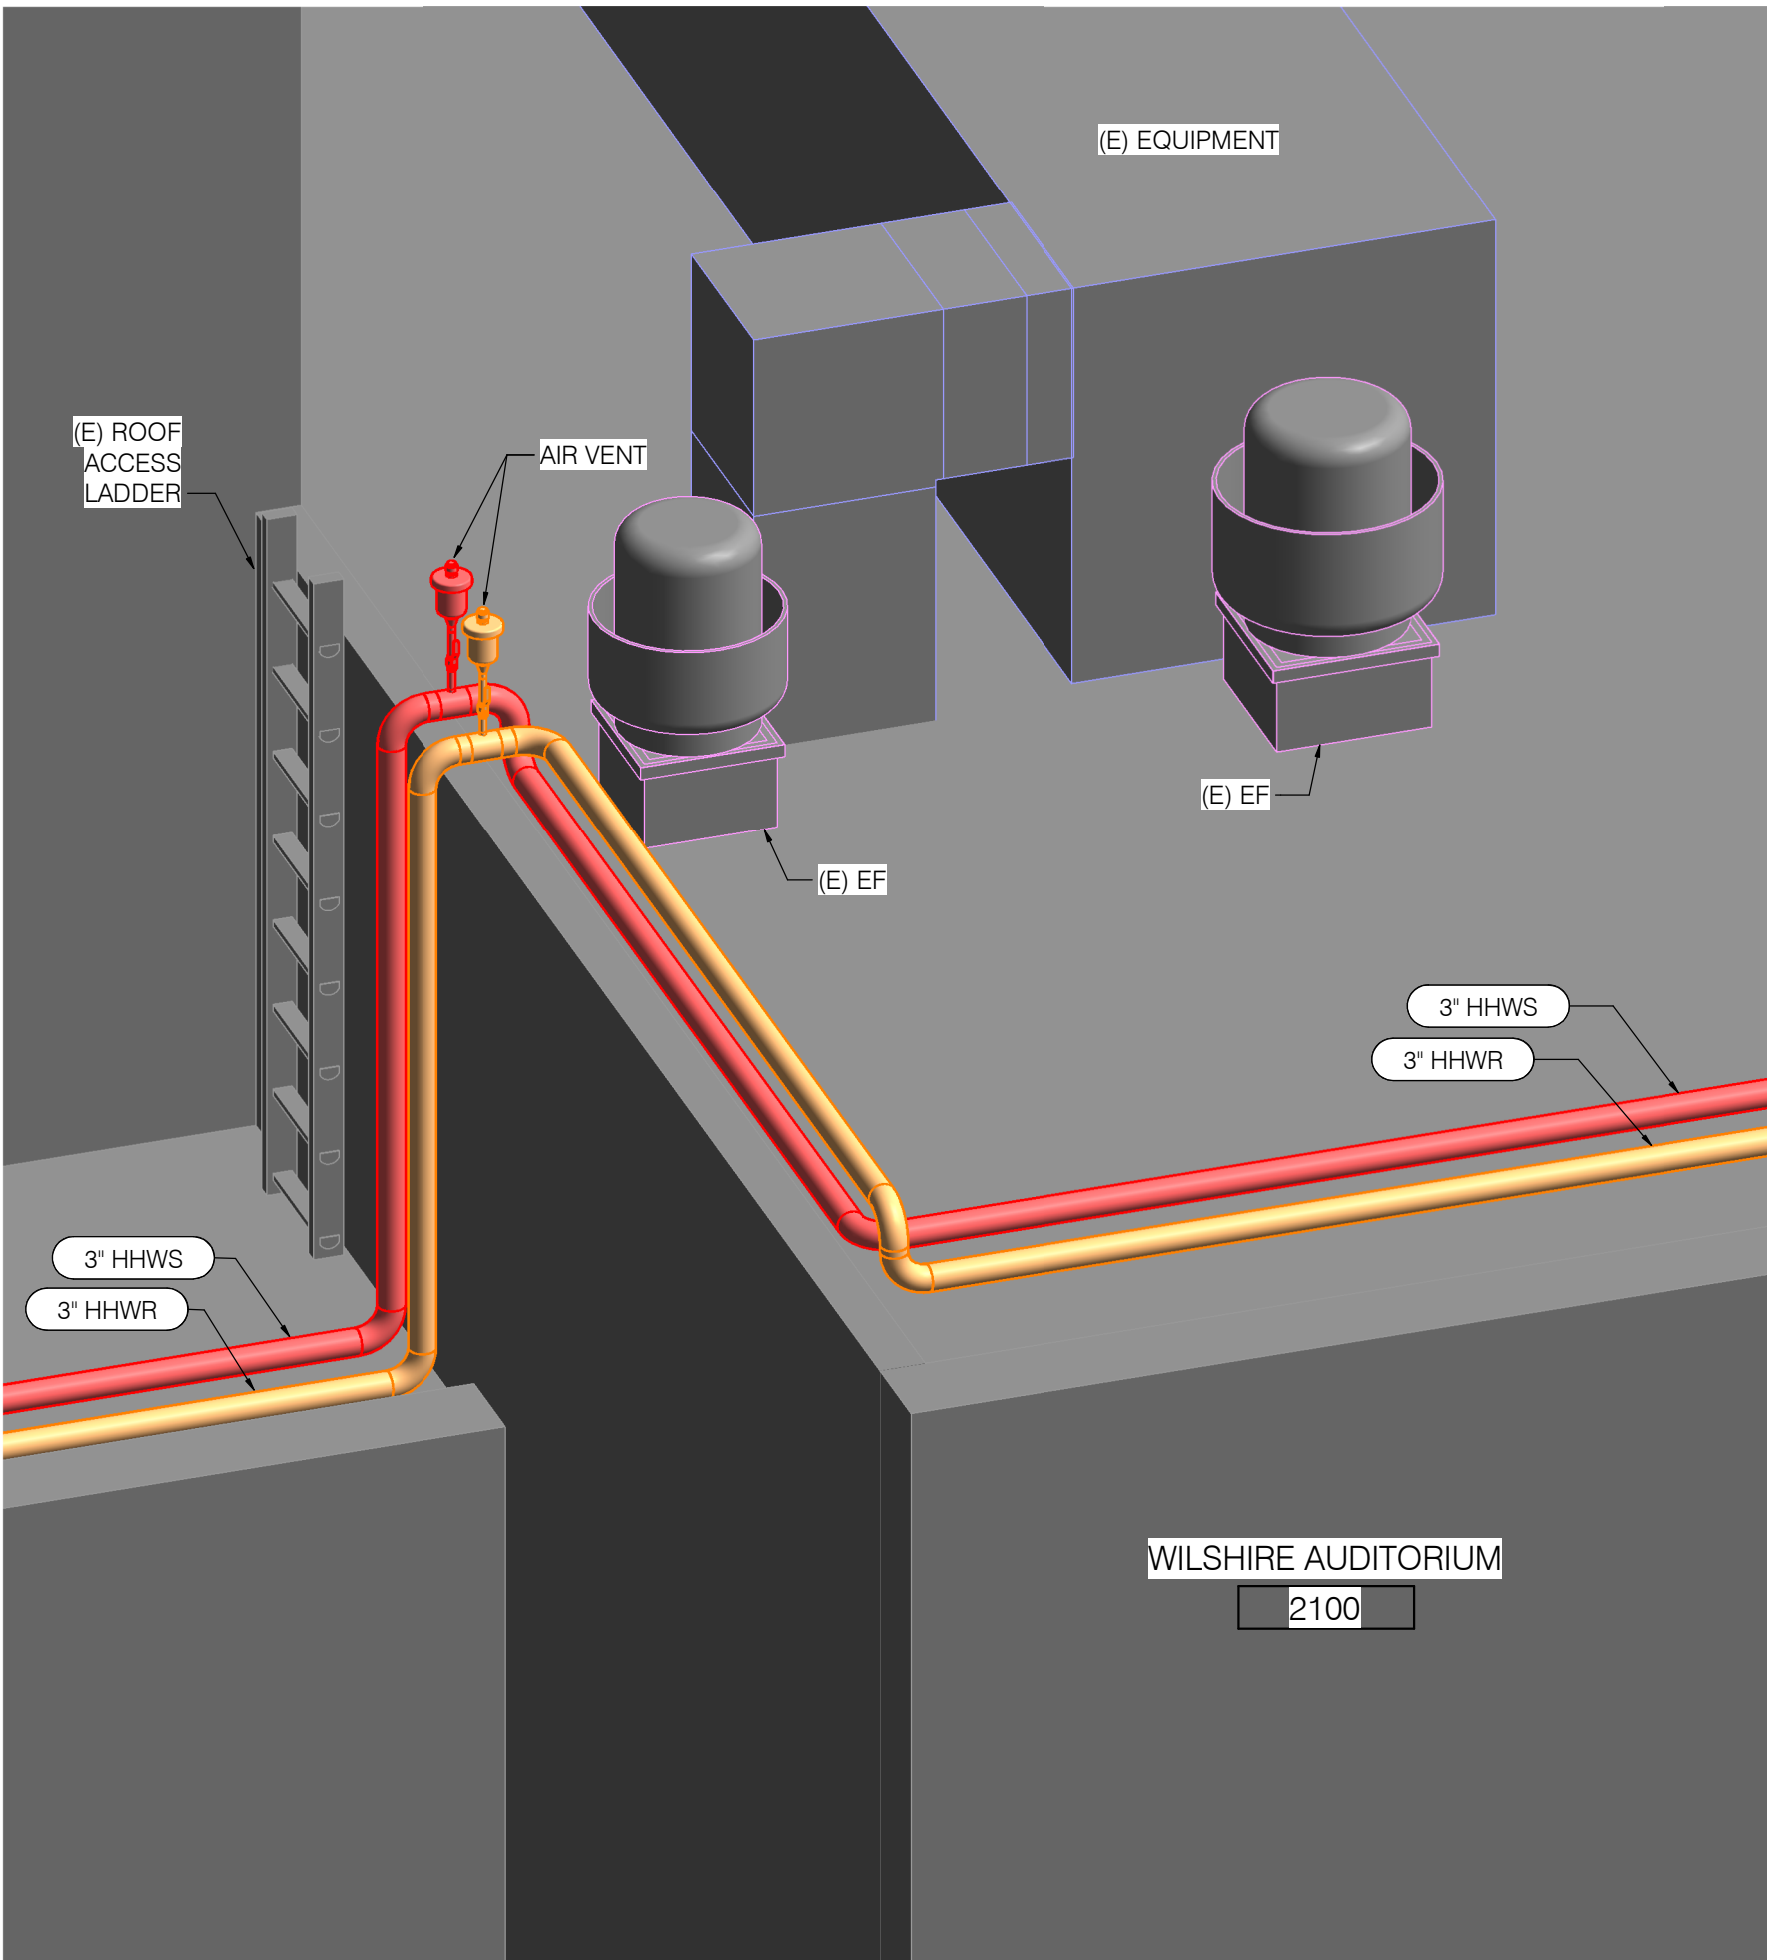

3 PIPE AWNING ISOMETRIC - BUILDING 100 TO BUILDING 200

SCALE: NONE

MATERIAL CONNECTION

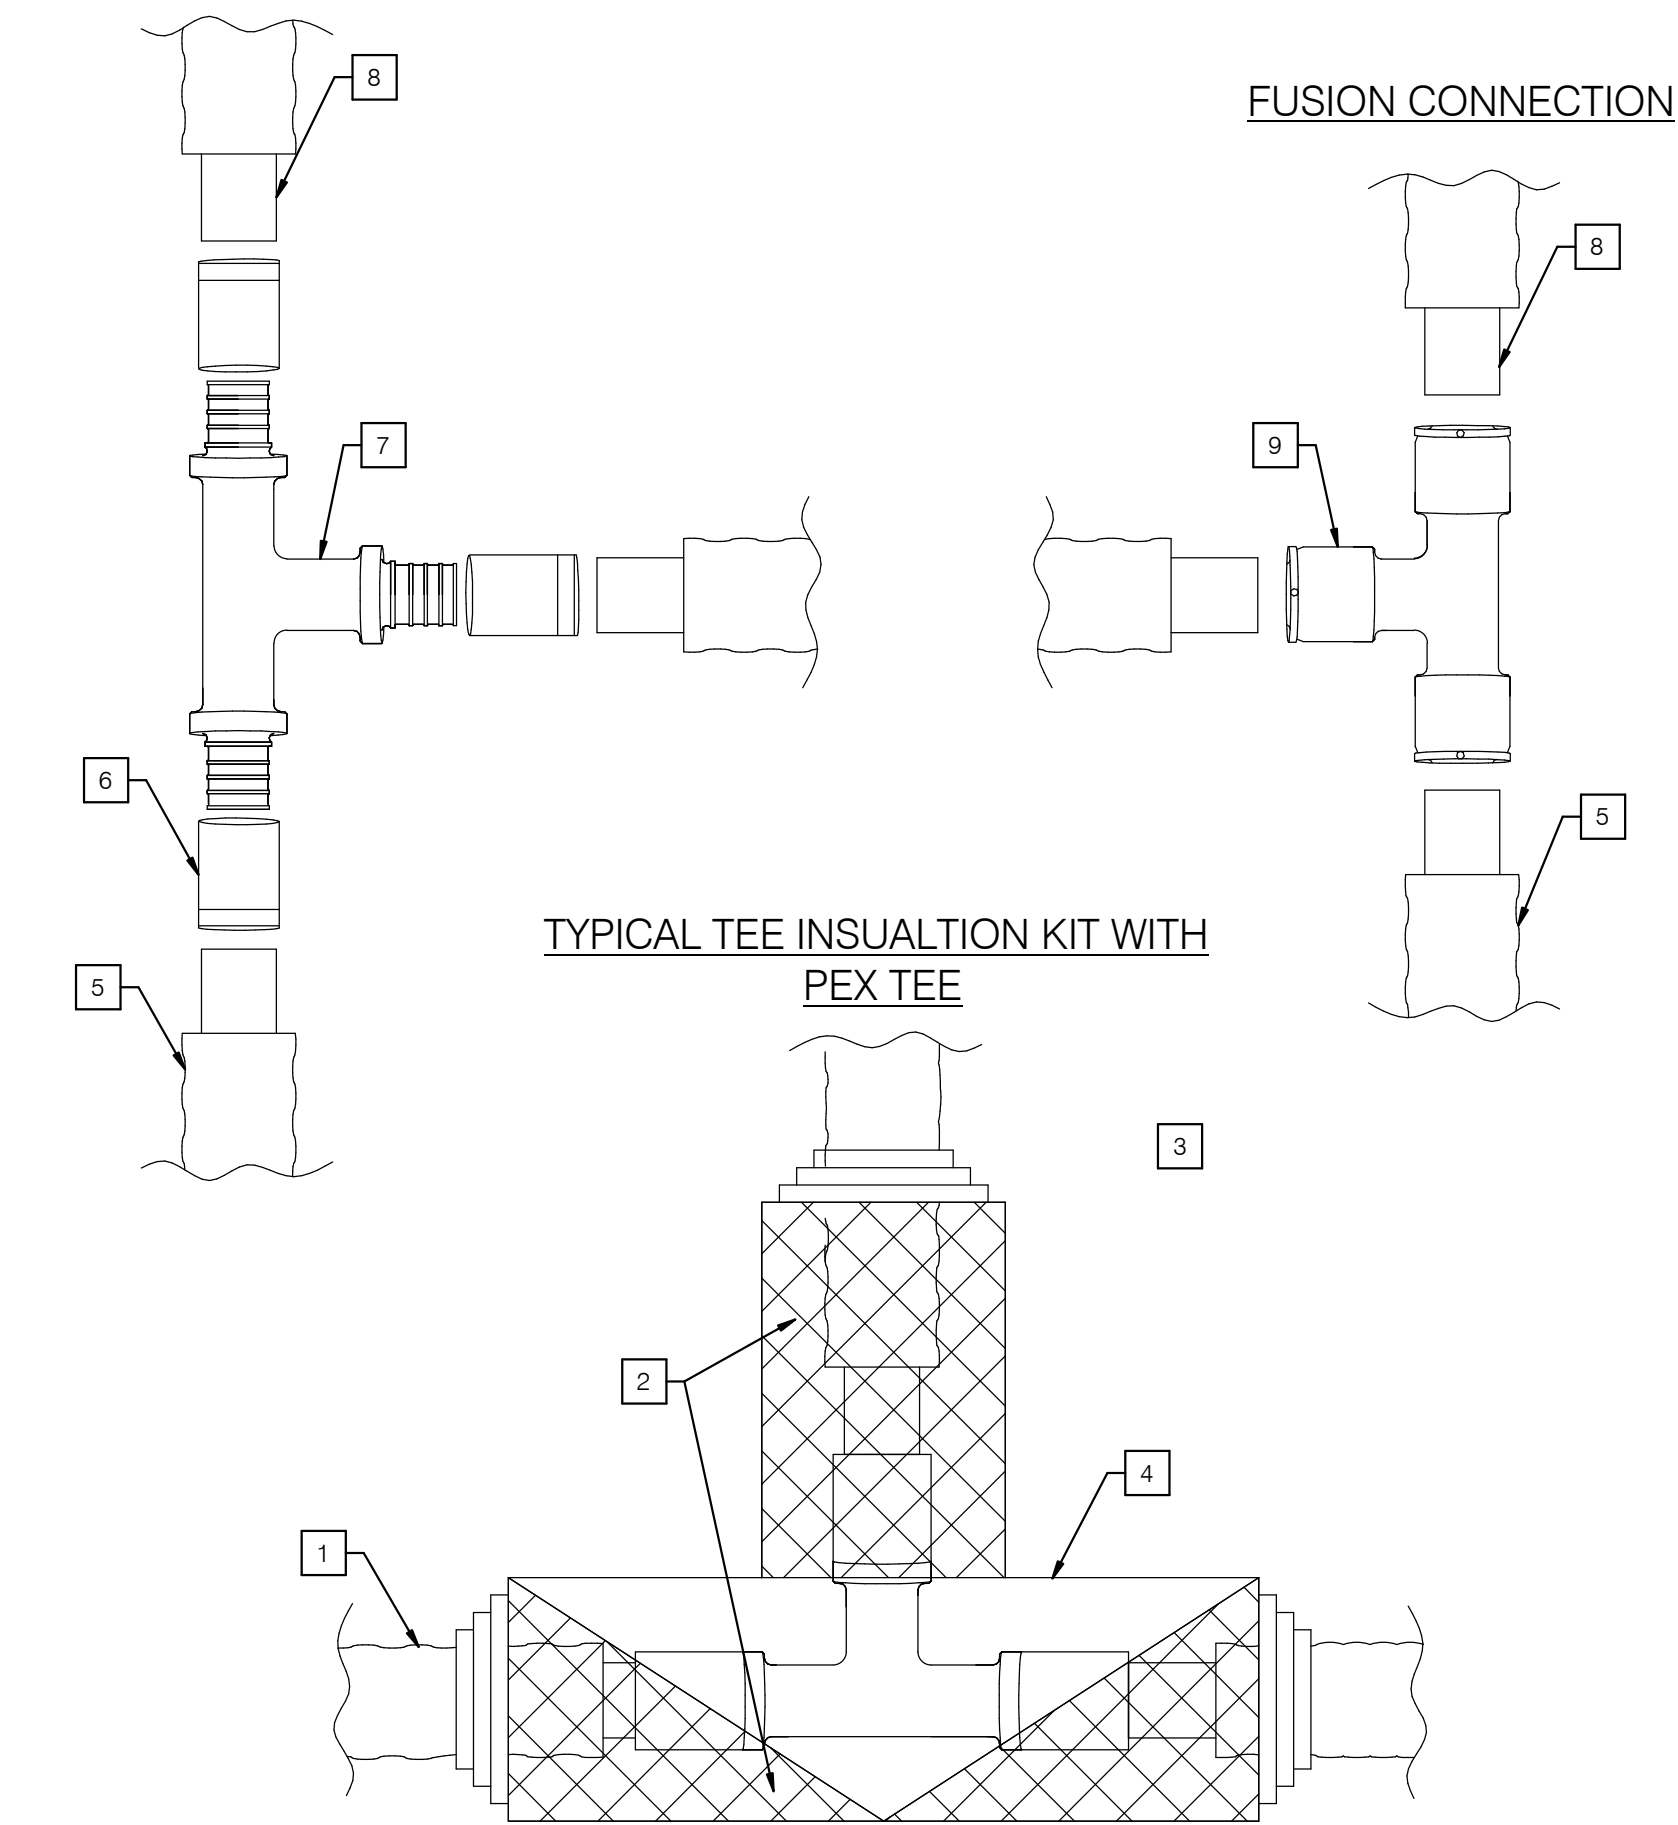


- NOTES
- 1 PIPE JACKET
 - 2 HEAT SHRINK SLEEVE
 - 3 STEPPED EDGE CUT BASED ON OUTSIDE PIPE JACKET SIZE
 - 4 TEE SHAPED PLASTIC SHELL
 - 5 PIPE JACKET. CONTRACTOR SHALL REMOVE A MINIMUM OF 7" OF INSULATION FOR FITTING ASSEMBLY
 - 6 SLEEVE
 - 7 METAL TEE
 - 8 02 BARRIER PIPE
 - 9 PEX FUSIBLE TEE
 - 10 CONTRACTOR SHALL REFER TO MAUFACTURERS INSTALLATION GUIDE FOR DETAILED INSTALLATION INSTRUCTIONS

6 TYPICAL CONNECTIONS
NO SCALE

FUSION CONNECTION


MATERIAL CONNECTION

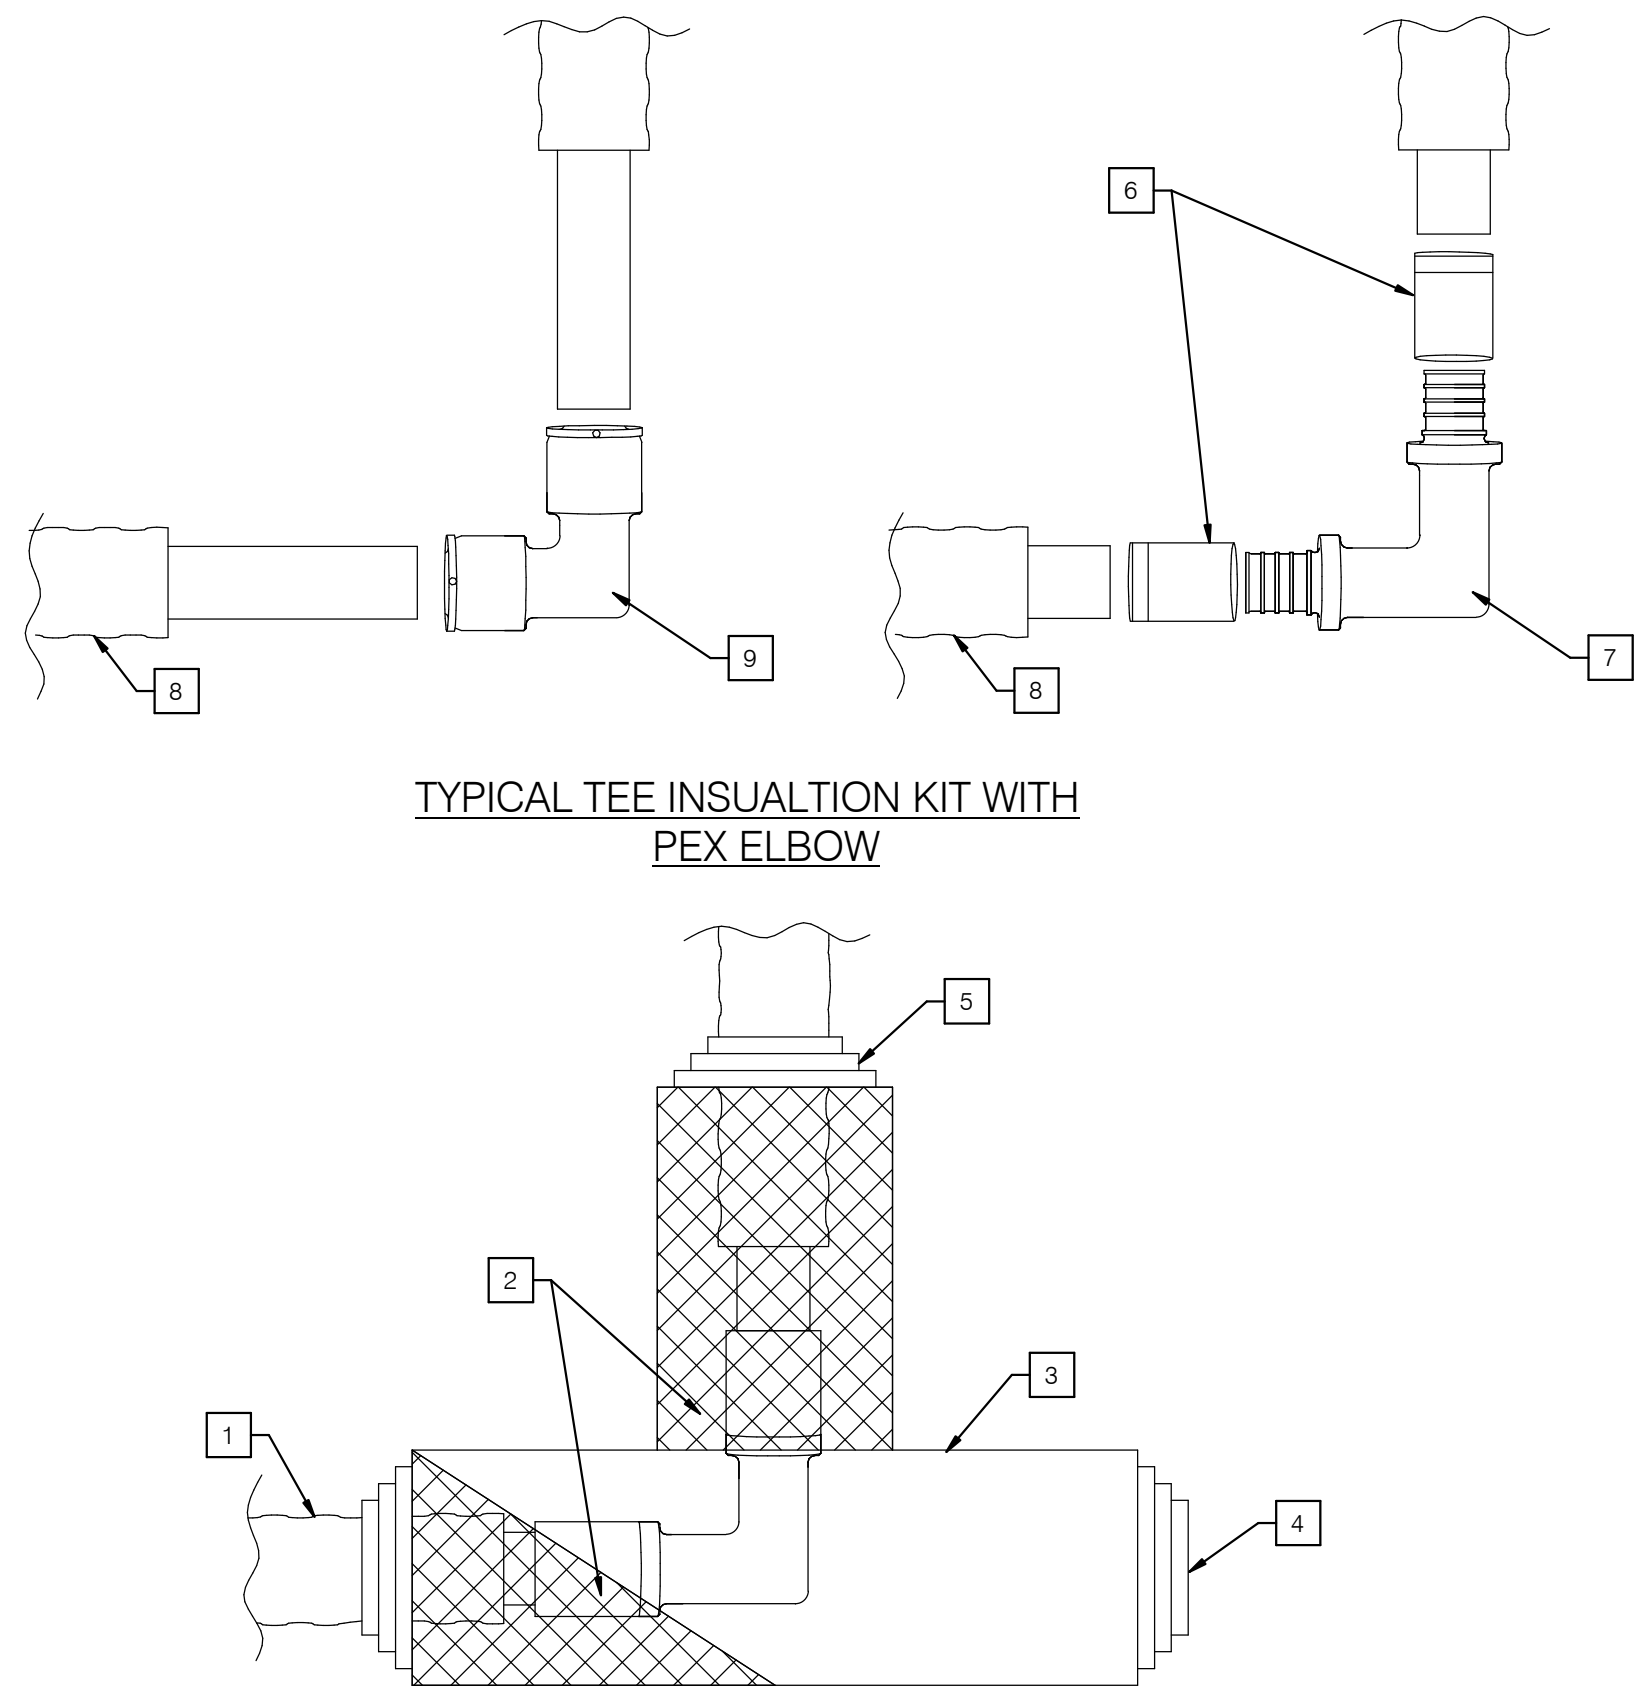

- NOTES
- 1 OUTSIDE JACKET
 - 2 HEAT SHRINK SLEEVE
 - 3 TEE SHAPED PLASTIC SHELL
 - 4 STEPPED EDGE-REMAINS UNCUT
 - 5 CUT BASED ON OUTSIDE PIPE JACKET SIZE
 - 6 METAL SLEEVE
 - 7 METAL ELBOW
 - 8 INSULPEX LDPE JACKET. CONTRACTOR SHALL REMOVE A MINIMUM OF 7" OF INSULATION FOR FITTING ASSEMBLY
 - 9 FUSIBLE PEX ELBOW
 - 10 CONTRACTOR SHALL REFER TO MANUFACTURERS INSTALLATION GUIDE FOR DETAILED INSTALLATION INSTRUCTIONS


4 TYPICAL CONNECTIONS
NO SCALE

FUSION CONNECTION

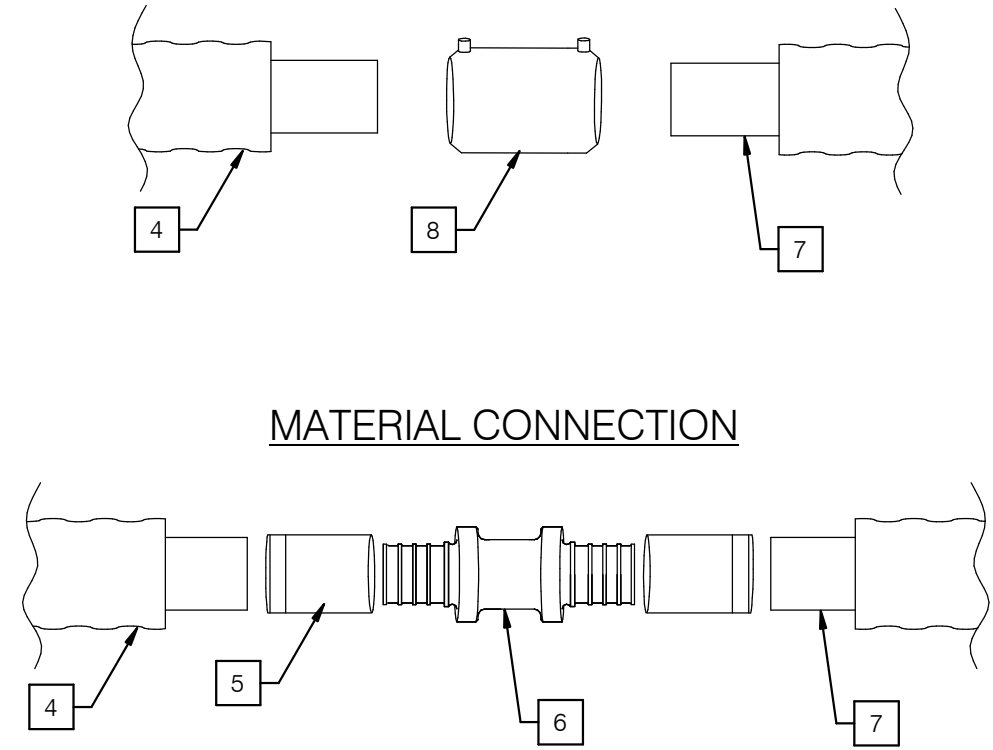


- NOTES
- 1 HEAT SHRINK SLEEVE
 - 2 COUPLING SHAPED PLASTIC SHELL
 - 3 STEPPED EDGE CUT BASED ON OUTSIDE PIPE JACKET SIZE
 - 4 OUTSIDE JACKET. CONTRACTOR SHALL REMOVE A MINIMUM OF 7" OF INSULATION FOR FITTING ASSEMBLY
 - 5 SLEEVE
 - 6 METAL COUPLING
 - 7 02 BARRIER PIPE
 - 8 FUSIBLE PEX COUPLING
 - 9 CONTRACTOR SHALL REFER TO MANUFACTURERS INSTALLATION GUIDE FOR DETAILED INSTALLATION INSTRUCTIONS

2 TYPICAL CONNECTIONS
NO SCALE

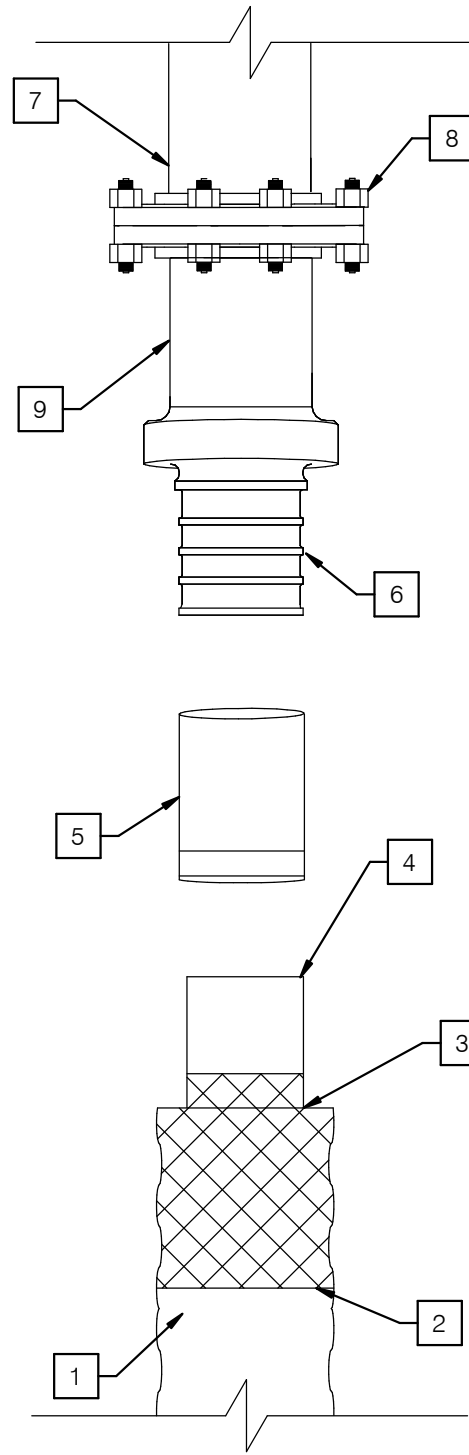


- NOTES
- 1 PRE-INSULATED PEX PIPE
 - 2 END CAP
 - 3 JACKET. CONTRACTOR SHALL REMOVE A MINIMUM OF 7" OF INSULATION FOR FITTING ASSEMBLY
 - 4 PEX PIPE
 - 5 PIPE COUPLING SLEEVE
 - 6 MALE THREADED ADAPTER
 - 7 CARBON STEEL WELDING ENDS
 - 8 FLANGE CONNECTION
 - 9 MALE THREADED ADAPTER

5 TYPICAL PEX TO METAL COUPLING
NO SCALE

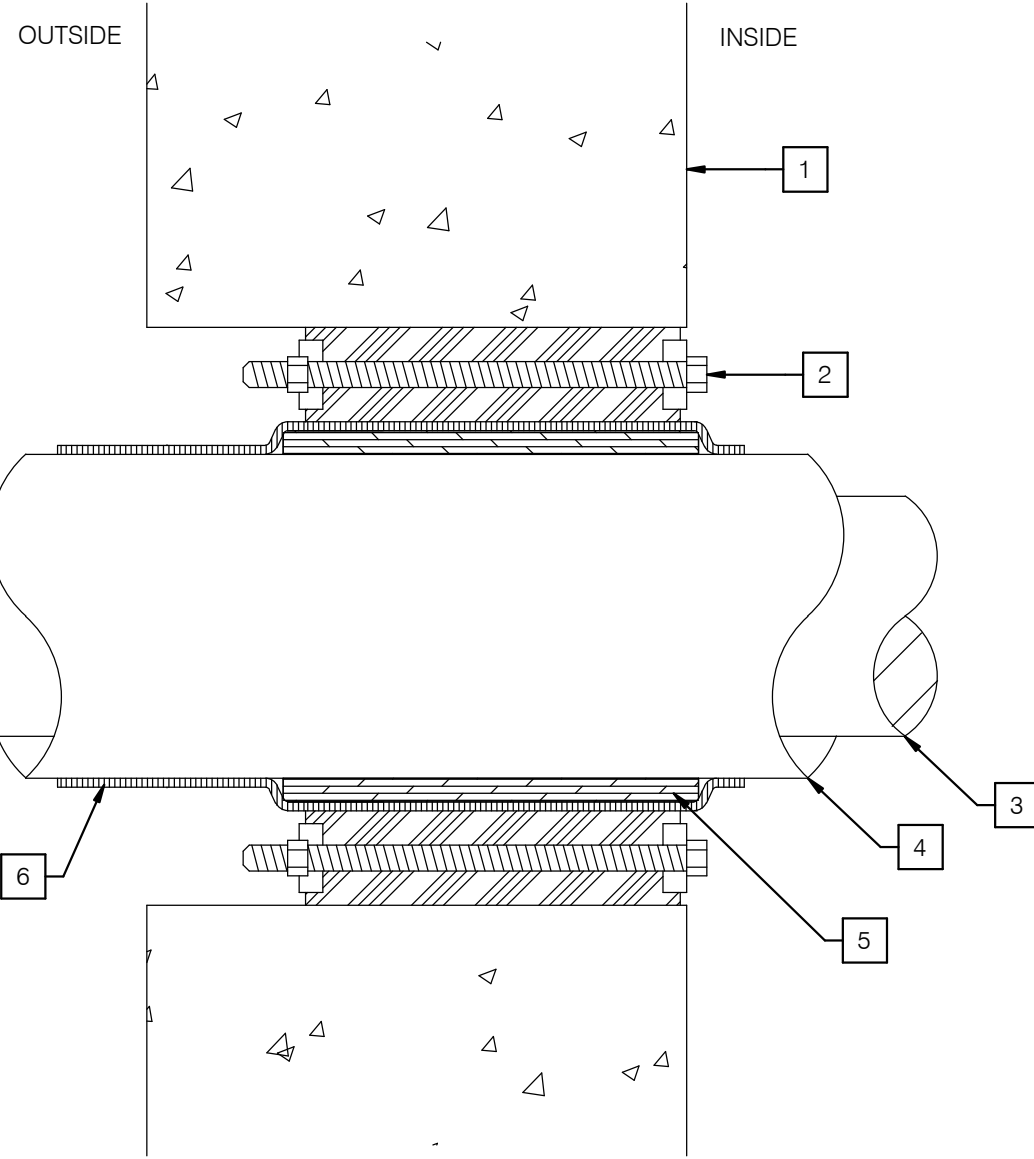


- NOTES
- 1 CONCRETE WALL
 - 2 WATER PROOF LINK SEAL ASSEMBLY
 - 3 CARRIER PIPE
 - 4 INSULATION AND JACKET
 - 5 REINFORCE PIPE JACKET AS NECESSARY TO AVOID COLLAPSING OF JACKET WHEN INSTALLING LINK SEAL
 - 6 HDPE OR HEAT SHRINK

3 PIPE PENETRATION THROUGH CONCRETE WALL
NO SCALE

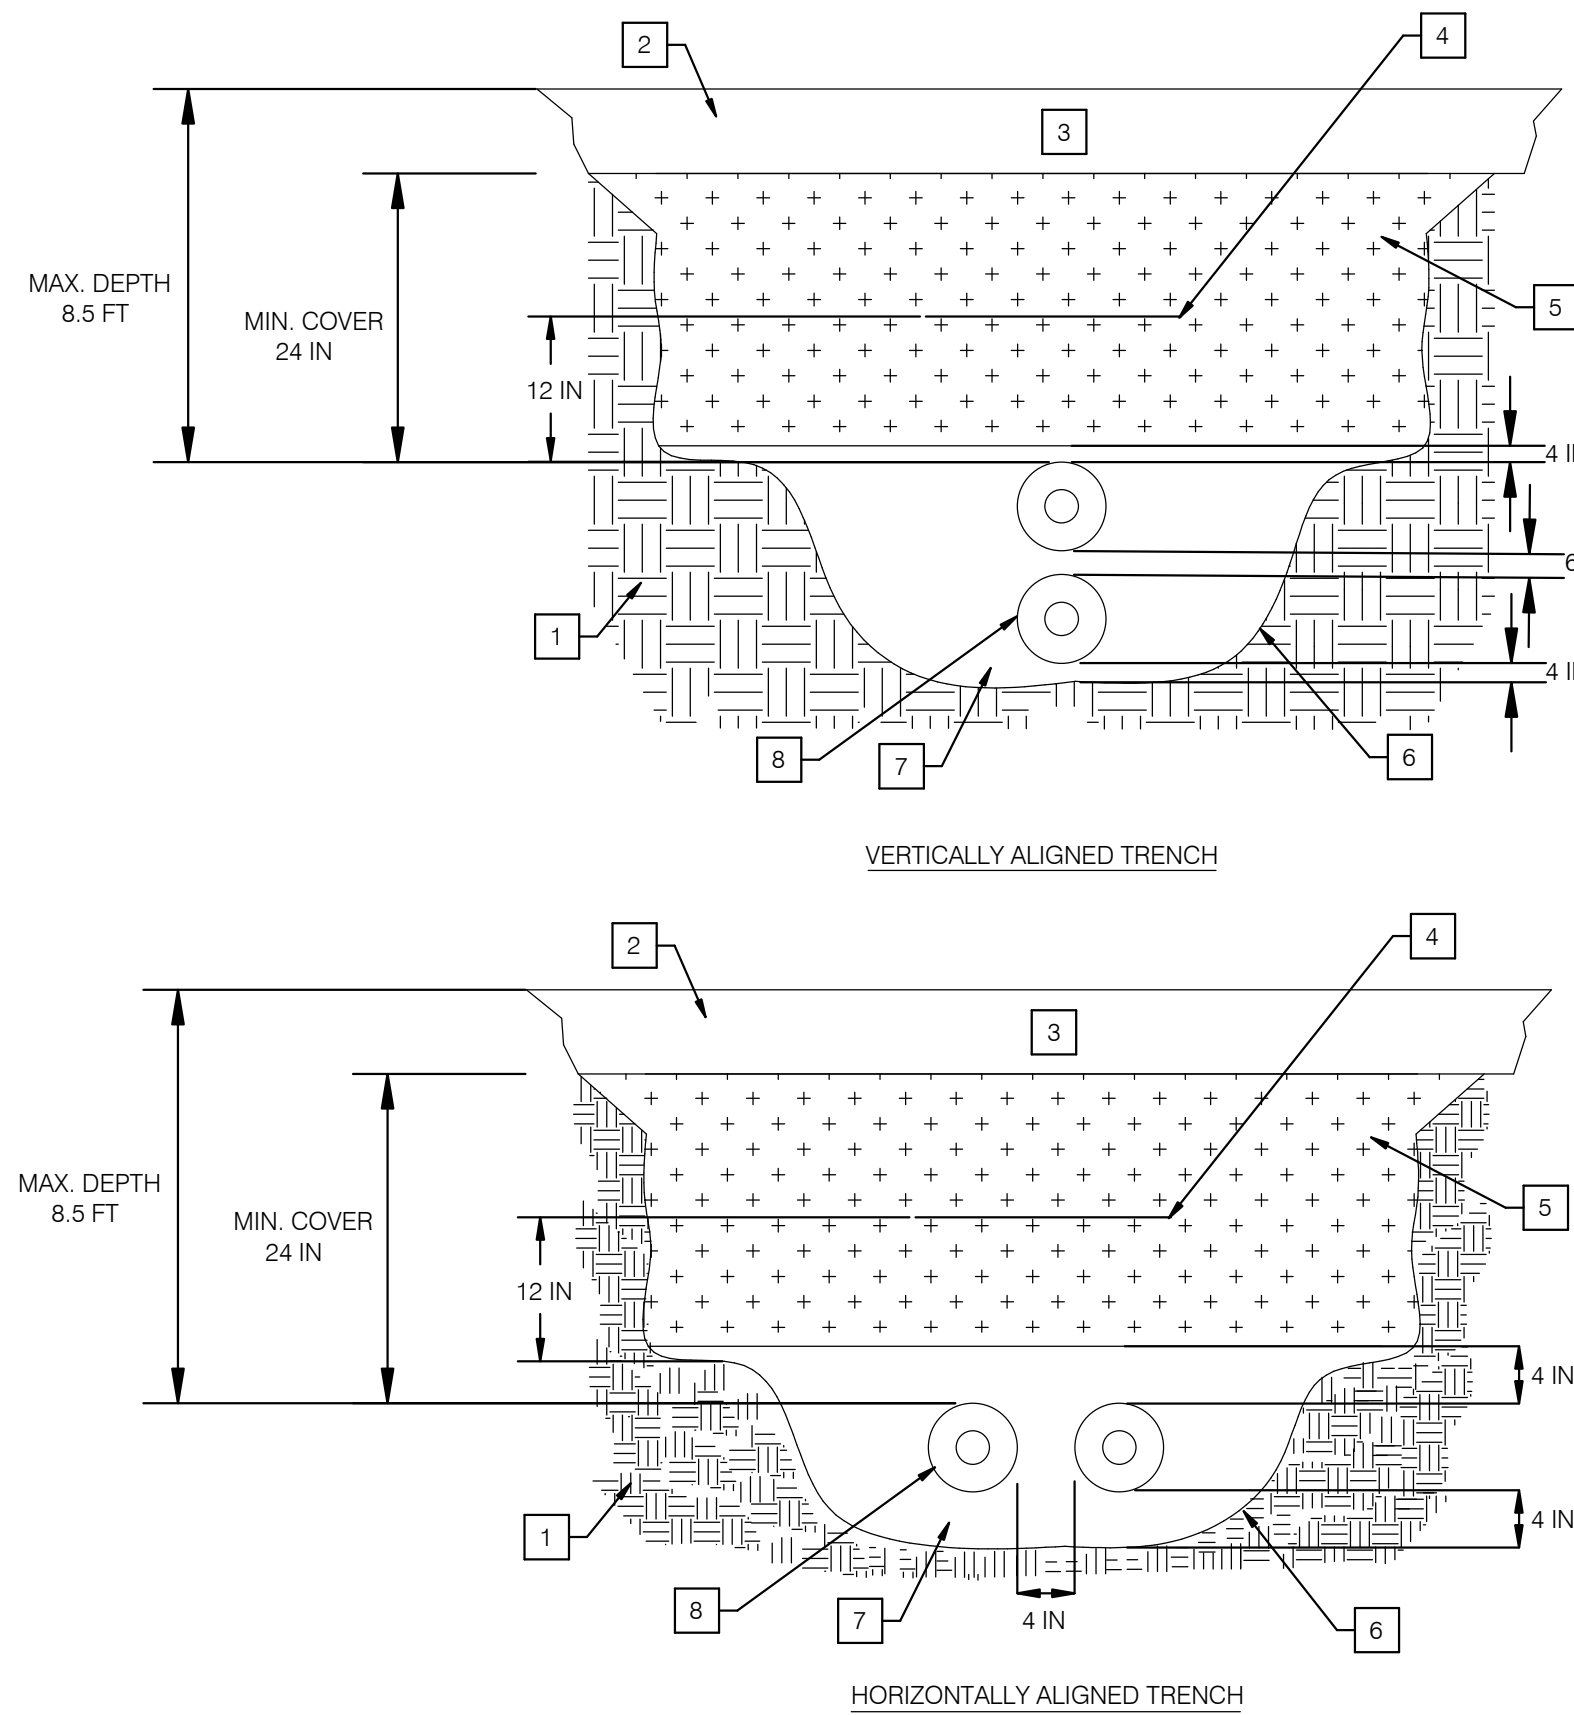

- NOTES
- 1 UNEXCAVATED EARTH
 - 2 H2O LOAD
 - 3 ROAD BED
 - 4 WARNING TAPE
 - 5 EXCAVATED MATERIAL
 - 6 EDGE OF TRENCH
 - 7 SAND
 - 8 PEX PIPE
 - 9 THIS DETAIL IS INTENDED AS A GENERAL INSTALLATION PURPOSES. VERIFY ACTUAL CONSTRUCTION OF ROAD BED WITH CIVIL PLANS

1 TYPICAL TWO-PIPE PEX TRENCH
NO SCALE

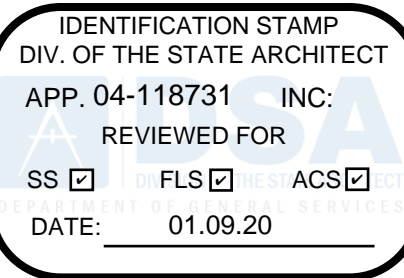

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Project Title

Heating Hot Water
Replacement Parking Lot 10

Owner



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1	DSA Submittal	10/29/2019
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Designed T Mueller
Drawn T Mueller
Checked C Dean
Approved M Phillips

Date January 8, 2020

Submittal DSA Back Check

Scale No Scale

Sheet Title

Details

Sheet Number

M601

P2S No. 9570

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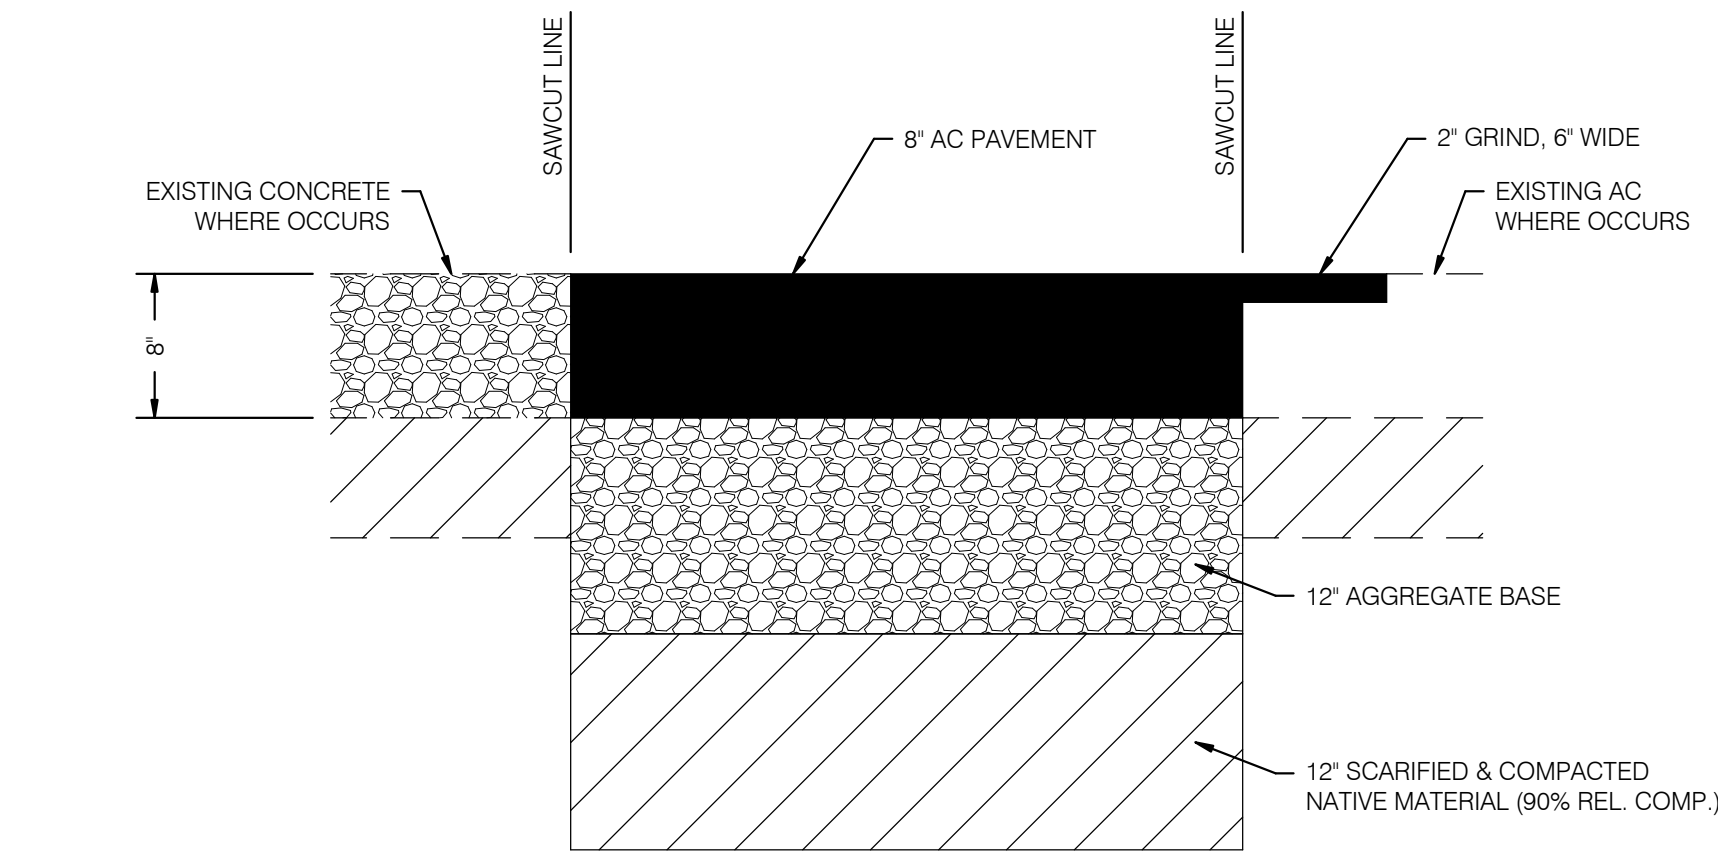
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B

C

D


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GENERAL NOTES

1. ALL PATCHES TO AC PAVEMENT SHALL COMPLY WITH 2016 CALIFORNIA BUILDING CODE, CHAPTER 11B, SECTION 302.1 AND SECTION 303.


4 AC PAVEMENT
NO SCALE



GENERAL NOTES

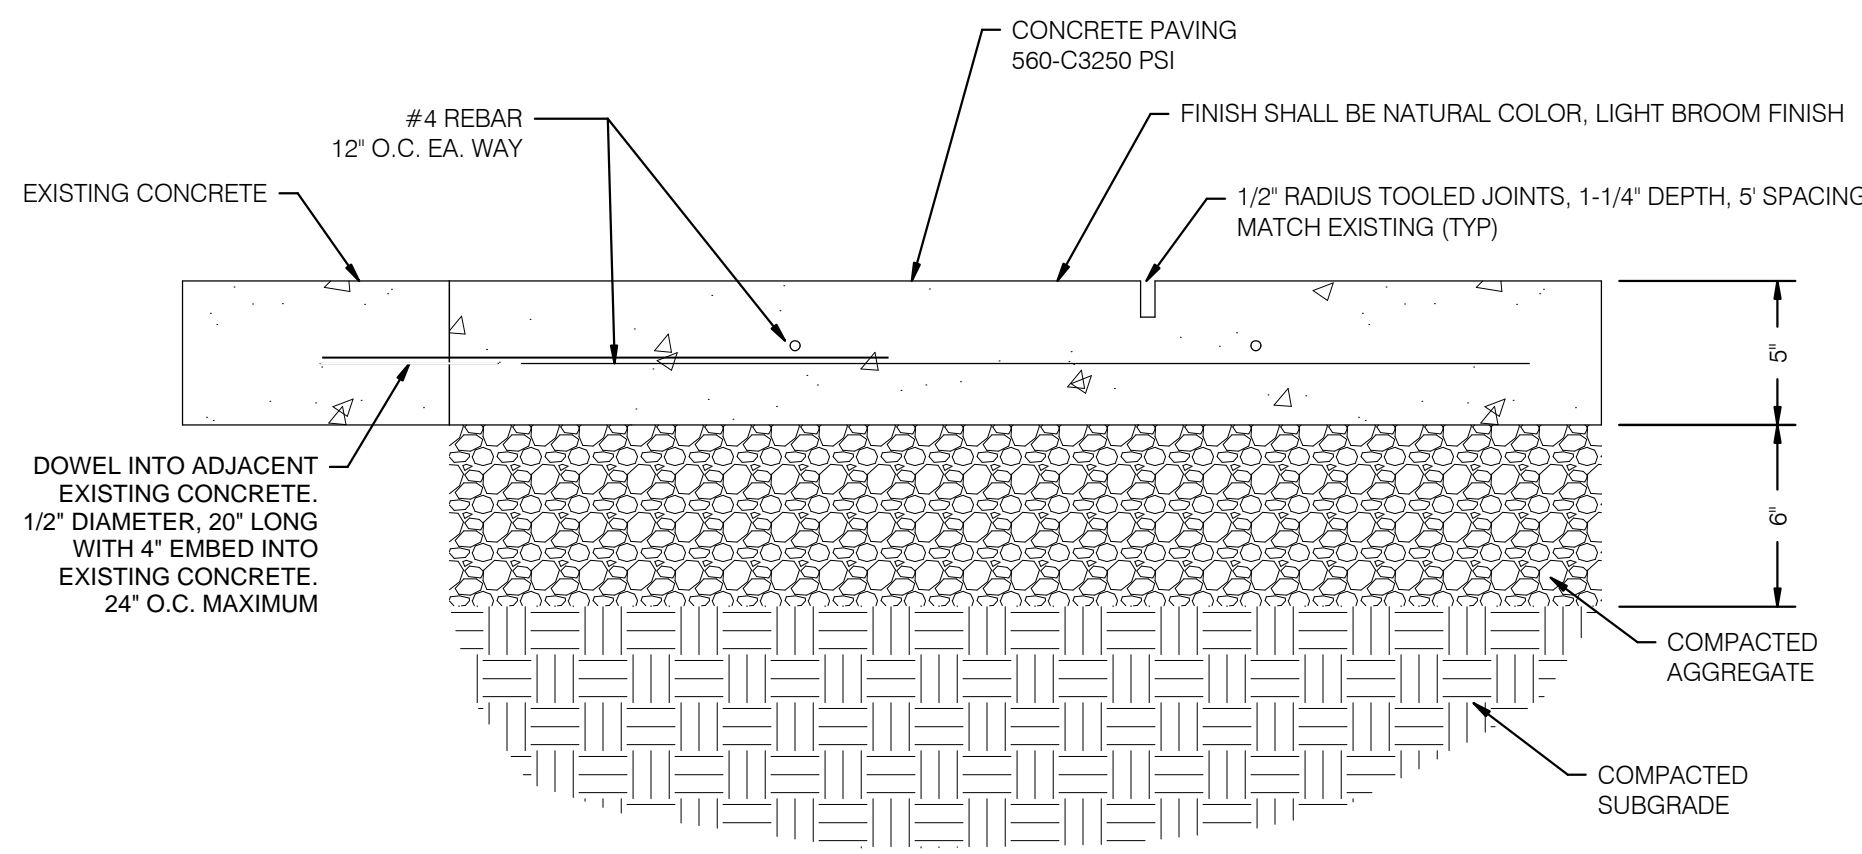1. ALL PATCHES TO CONCRETE SHALL COMPLY WITH 2016 CALIFORNIA BUILDING CODE, CHAPTER 11B, SECTION 302.1 AND SECTION 303.


3 CONCRETE PAVING
NO SCALE

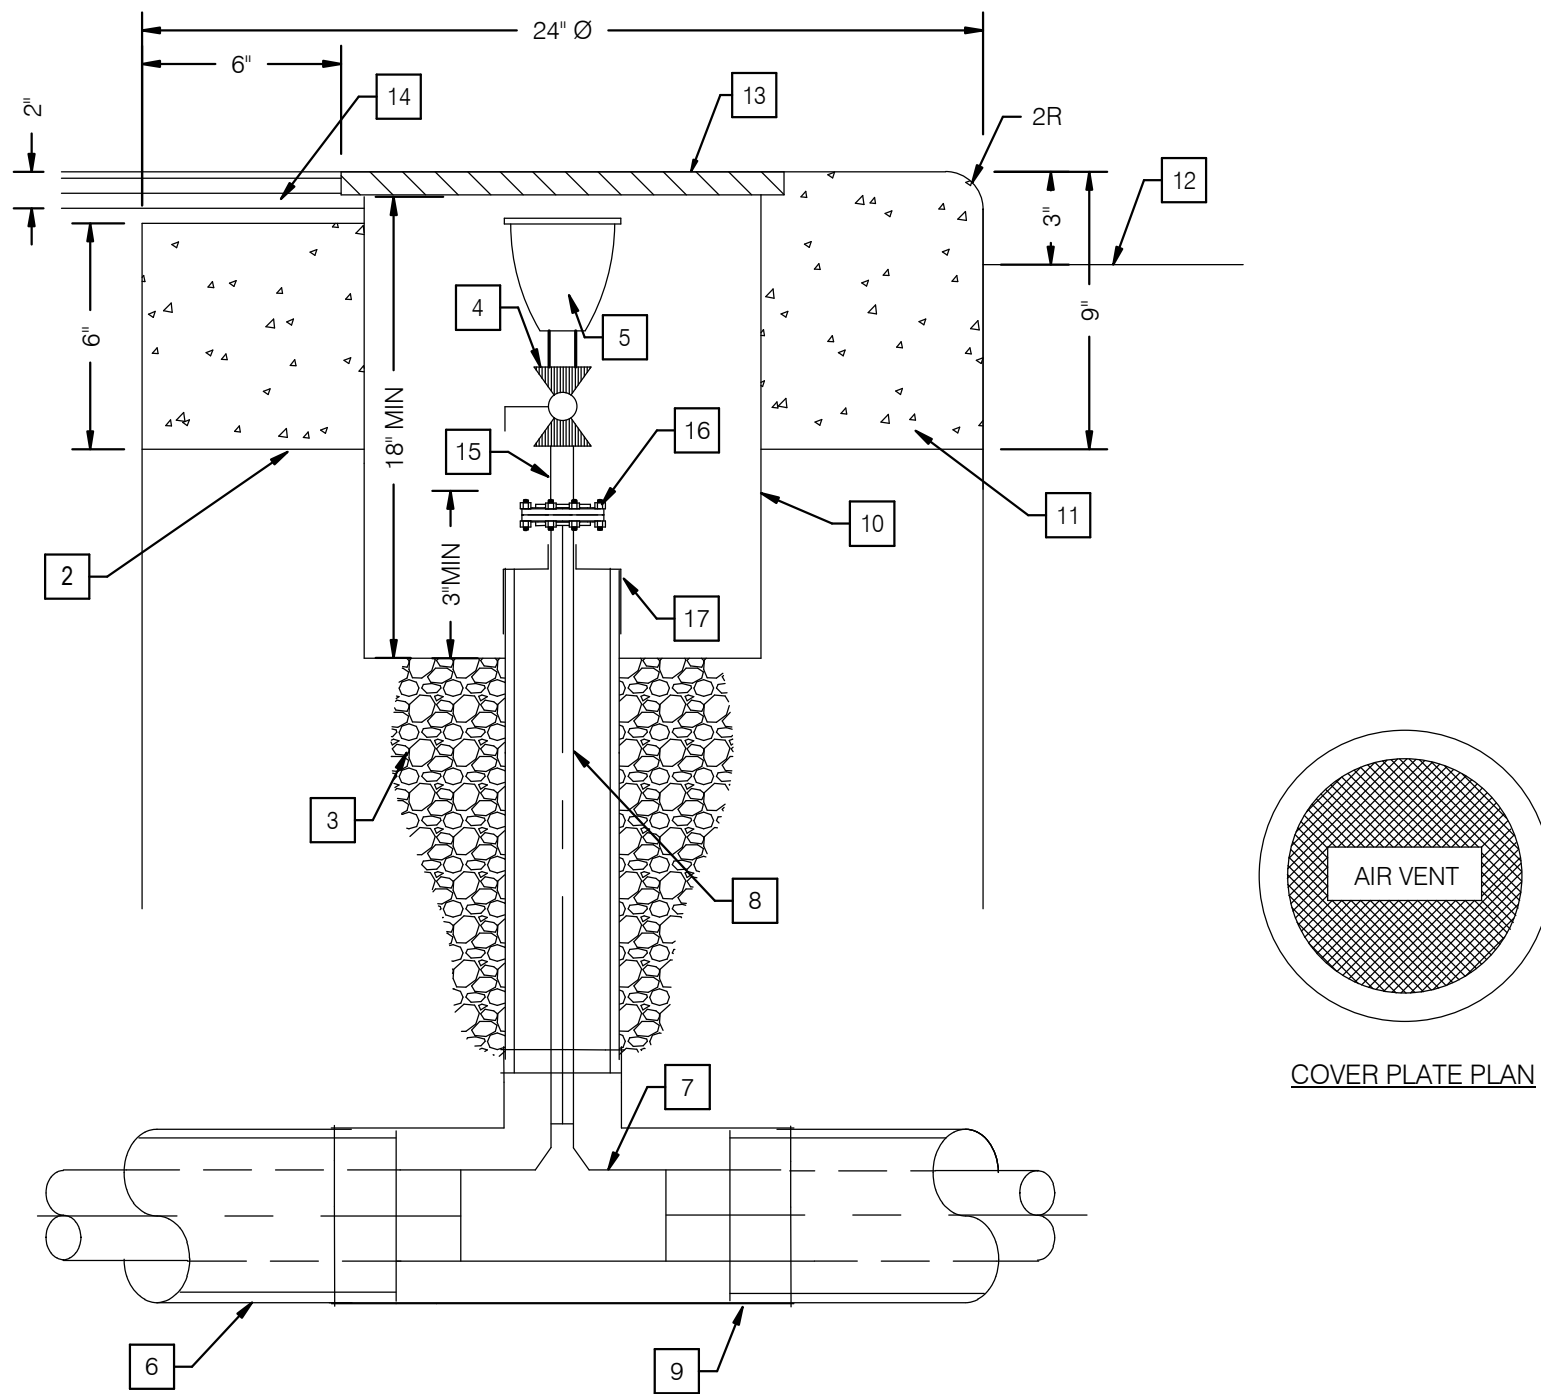

NOTES

1. WHERE RISERS ARE PROVIDED SIDE BY SIDE AND CONCRETE RINGS OVERLAP PROVIDE A SINGLE, OVAL, CONCRETE RING THAT MEETS OVERALL EXTERIOR DIMENSIONS INDICATED.
2. PROVIDE CONCRETE RING AS SHOWN. EXTEND DOWN 18" OR PROVIDE SCH 40 PVC SLEEVE TO A DEPTH OF 18"
3. PROVIDE GRAVEL BASE 12" DEEP AND 12" WIDE AROUND AIR VENT RISER FOR DRAINAGE.
4. BALL VALVE
5. AUTOMATIC AIR VENT
6. PRE-INSULATED PEX PIPING
7. REDUCING TEE
8. 1" Ø PRE INSULATED PEX AIR VENT PIPE BY PIPING MANUFACTURER
9. MANUFACTURER INSULATION KIT. SEE DETAIL 6/M601.
10. VALVE BOX
11. CLASS 920-A-2500 CONCRETE COLLAR (TYP.)
12. FINISHED GROUND SURFACE IF INSTALLED UNDER LANDSCAPE
13. 12" SOLID MANHOLE COVER
14. A.C. OR P.C.C. PAVEMENT (MATCH EXISTING). SEE 1/M602, 3/M602, AND 4/M602 AS NECESSARY.
15. 1" Ø STEEL AIR VENT PIPE
16. FLANGE CONNECTION
17. POLYETHYLENE SHRINK END SEAL.


2 DIRECT BURIED PEX AIR VENT
NO SCALE

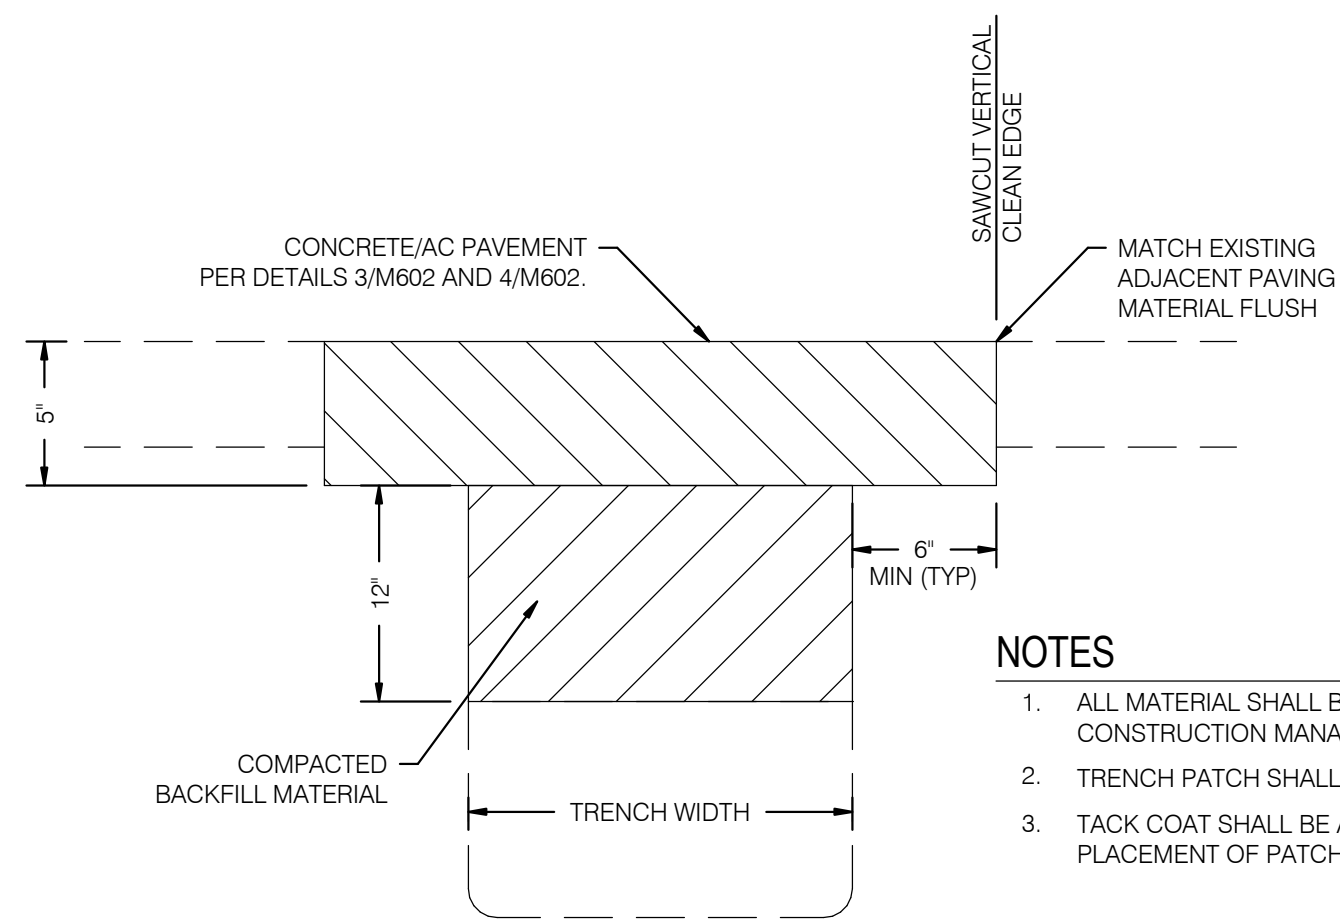

NOTES

1. ALL MATERIAL SHALL BE HOT PLANT MIX APPROVED BY CONSTRUCTION MANAGER.
2. TRENCH PATCH SHALL BE SAND-SEALED.
3. TACK COAT SHALL BE APPLIED TO ALL EDGES PRIOR TO PLACEMENT OF PATCH.

1 TYPICAL PAVEMENT TRENCH PATCH
NO SCALE

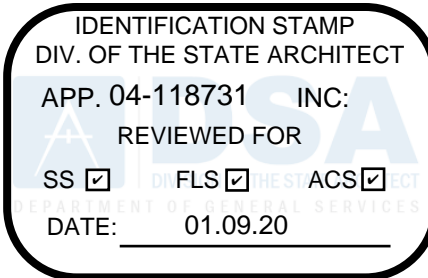

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Project Title

Heating Hot Water
Replacement Parking Lot 10

Owner



321 East Chapman Avenue
Fullerton, CA 92832



Revisions

Number	Description	Date
1	DSA Submittal	10/29/2019
2	DSA Back Check	1/8/2020

Designed T Mueller
Drawn T Mueller
Checked C Dean
Approved M Phillips

Date January 8, 2020

Submittal DSA Back Check

Scale No Scale


Sheet Title
Details

Sheet Number

M602

P2S No. 9570

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GENERAL NOTES
1. NO DEMOLITION SHALL BEGIN UNTIL PLANS INCLUDING THE DEMOLITION WORK HAVE BEEN APPROVED BY THE DIVISION OF THE STATE ARCHITECT.

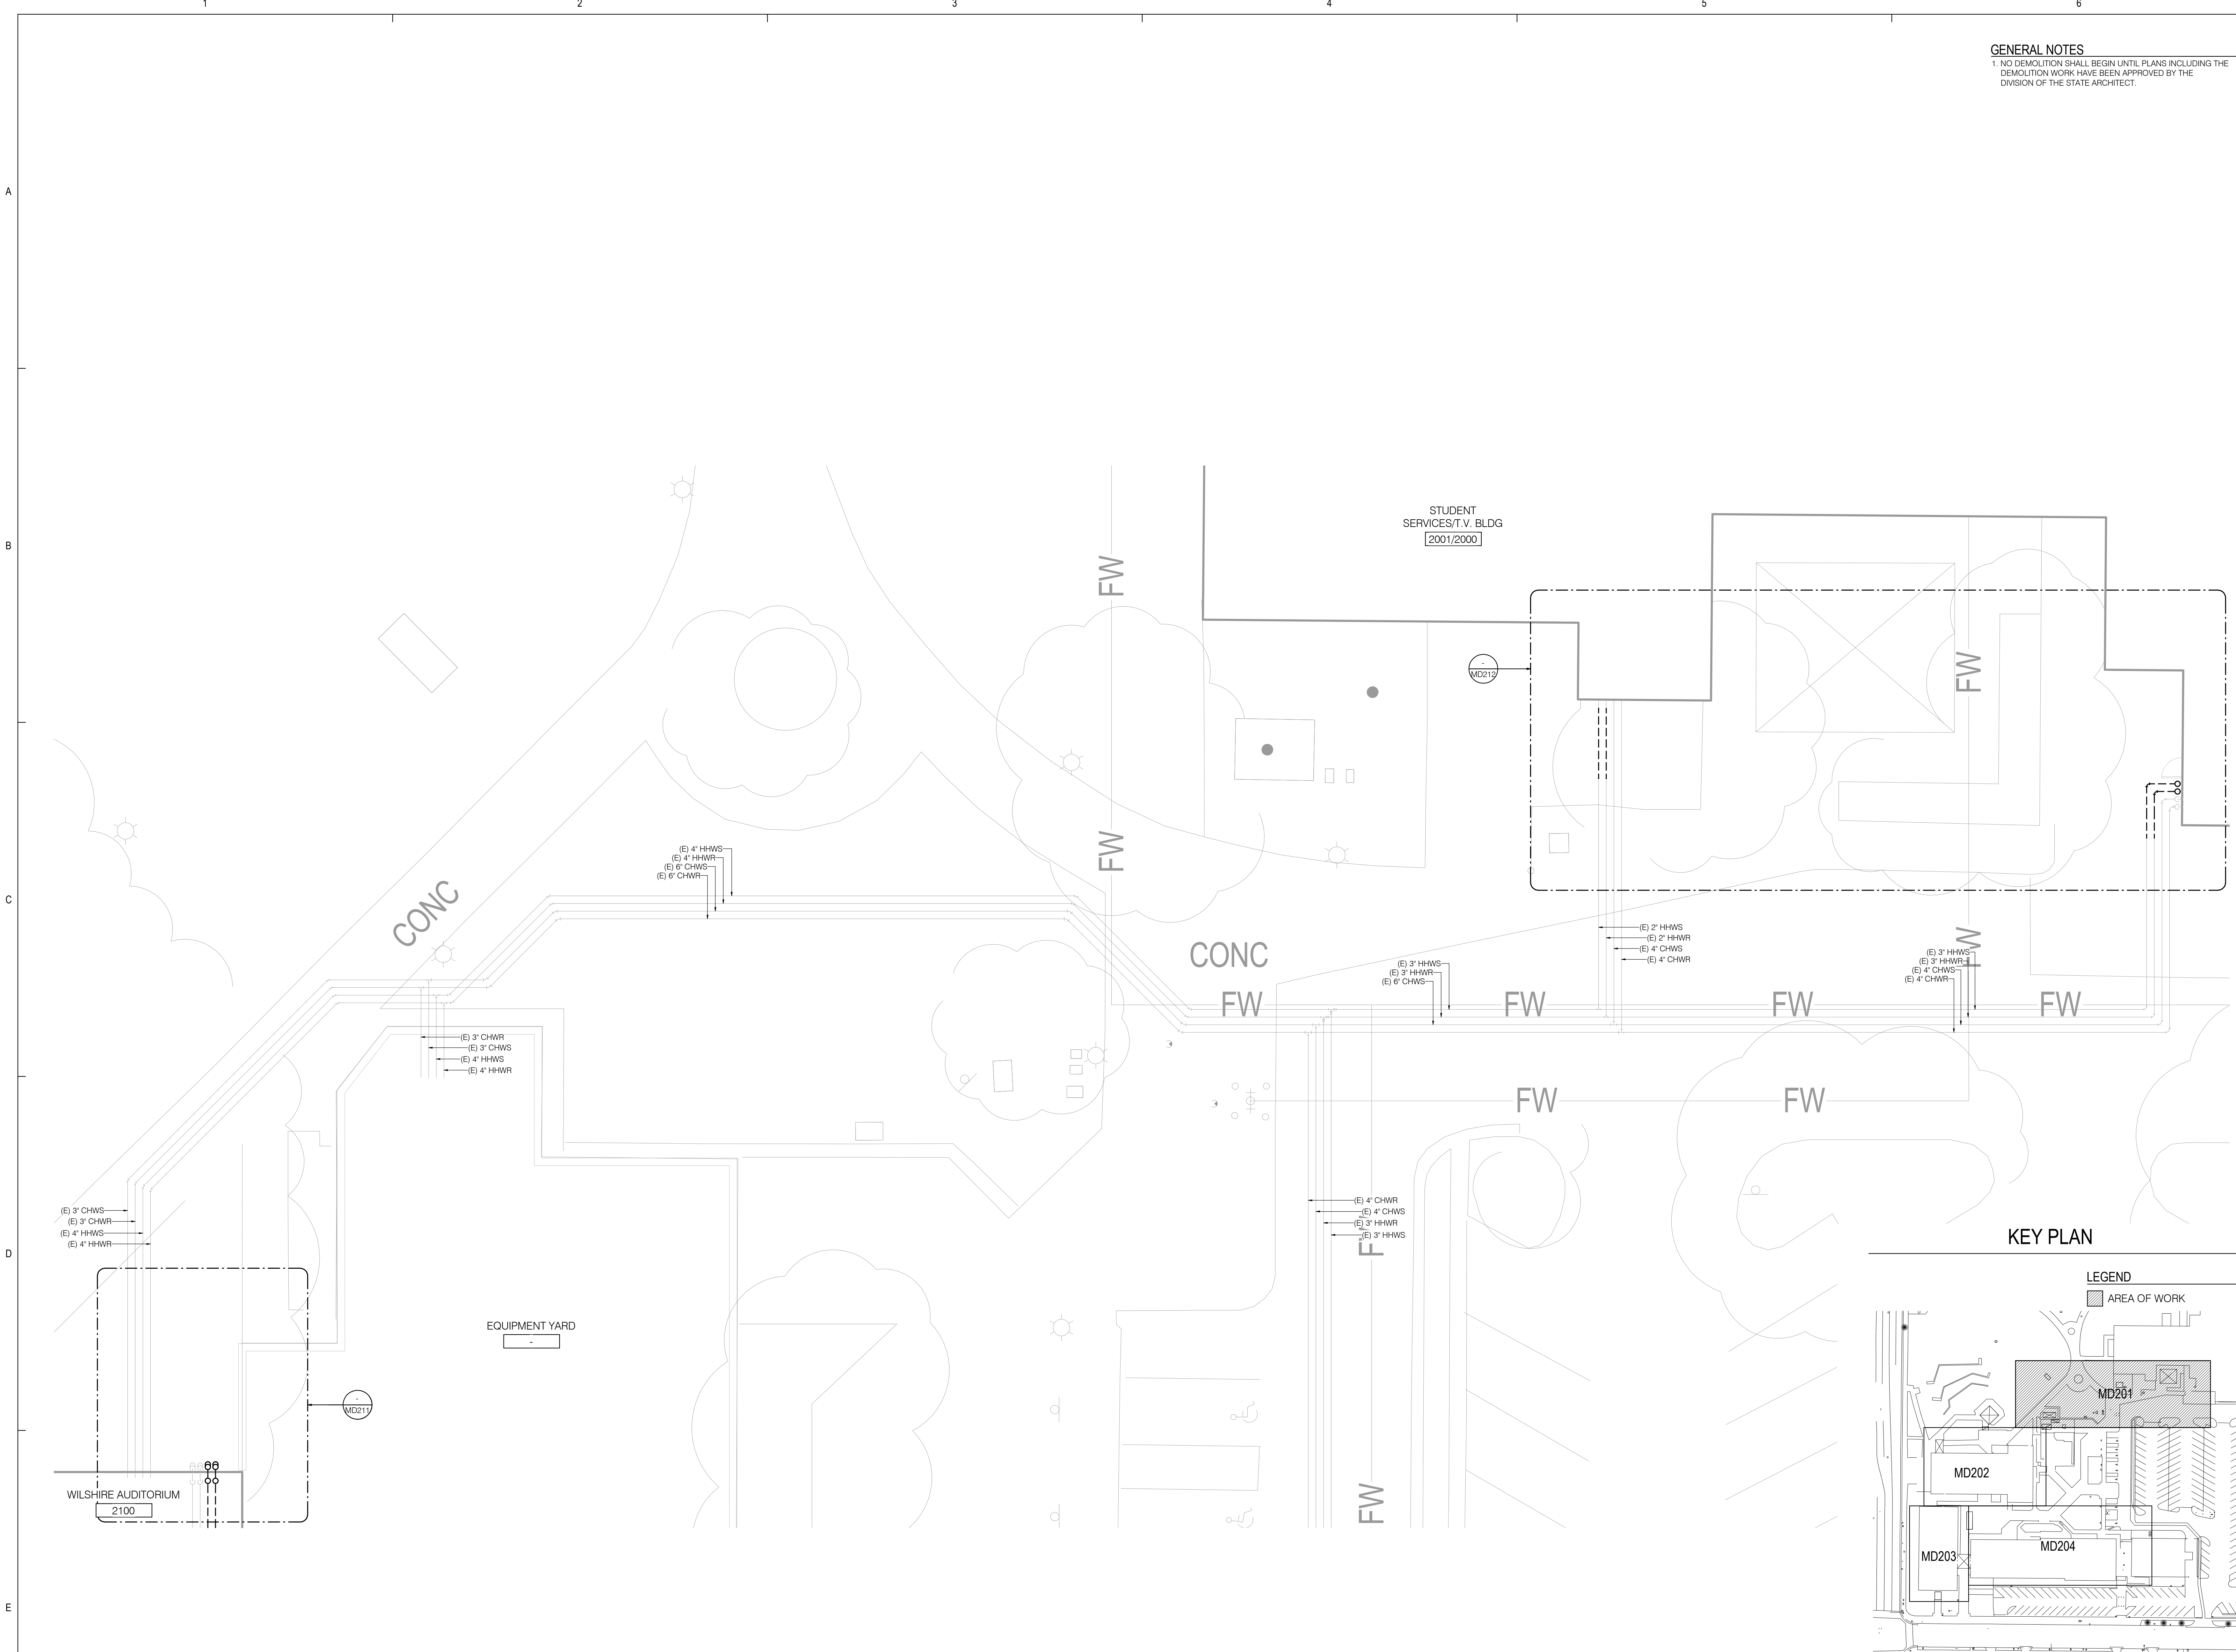IDENTIFICATION STAMP
DIV. OF THE STATE ARCHITECT
APP. 04-118731 INC.
REVIEWED FOR
SS ☒ FLS ☐ ACS ☐
DATE: 01.09.20



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Project Title
Heating Hot Water
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321 East Chapman Avenue
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Designed T Mueller
Drawn T Mueller
Checked C Dean
Approved M Phillips

Date January 8, 2020

Submittal DSA Back Check

Scale 1/8" = 1'-0"

Sheet Title
Enlarged Site Plan
Demolition

Sheet Number
MD201

Revisions		
Number	Description	Date
	DSA Submittal	10/29/2019
	DSA Back Check	1/8/2020

Designed	T Mueller
Drawn	T Mueller
Checked	C Dean
Approved	M Phillips

Date January 8, 2020

Submittal	DSA Back Check
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Scale $1/8" = 1'-0"$

Sheet Title

Enlarged Site Plan
Demolition

Sheet Number

MD202


P2S No. 9571

GENERAL NOTES

1. NO DEMOLITION SHALL BEGIN UNTIL PLANS INCLUDING THE DEMOLITION WORK HAVE BEEN APPROVED BY THE DIVISION OF THE STATE ARCHITECT.


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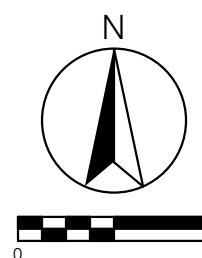
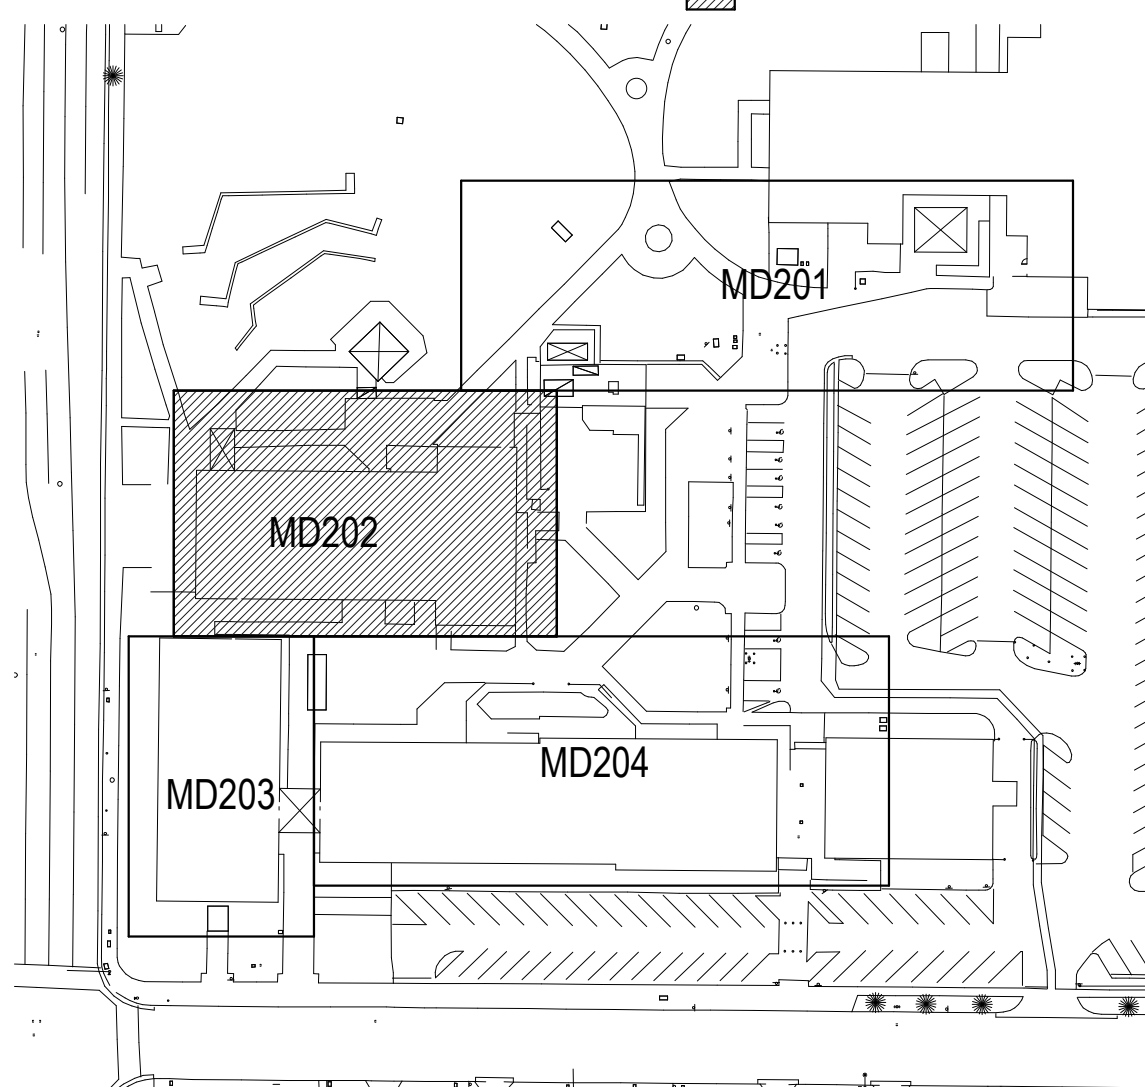
- 1 DEMOLISH EXISTING HWWS/R PIPES AND ATTACHED PIPING ACCESSORIES AS INDICATED. BRANCH PIPING SERVING EXISTING ROOFTOP UNITS TO REMAIN. ALL SURROUNDING PIPING, EQUIPMENT, AND ANCILLARY DEVICES SHALL BE PROTECTED IN PLACE.
- 2 EXISTING HWW PIPES AND EXISTING CHW PIPES FROM ROOFTOP DOWN TO GRADE AND PENETRATE THROUGH EXTERIOR WALL TO WILSHIRE AUDITORIUM BASEMENT STORAGE ROOM. SEE SHEET MD205.
- 3 EXISTING HWW PIPES AND EXISTING CHW PIPES PENETRATE THROUGH EXTERIOR WALL TO WILSHIRE AUDITORIUM BASEMENT STORAGE ROOM. SEE SHEET MD205.

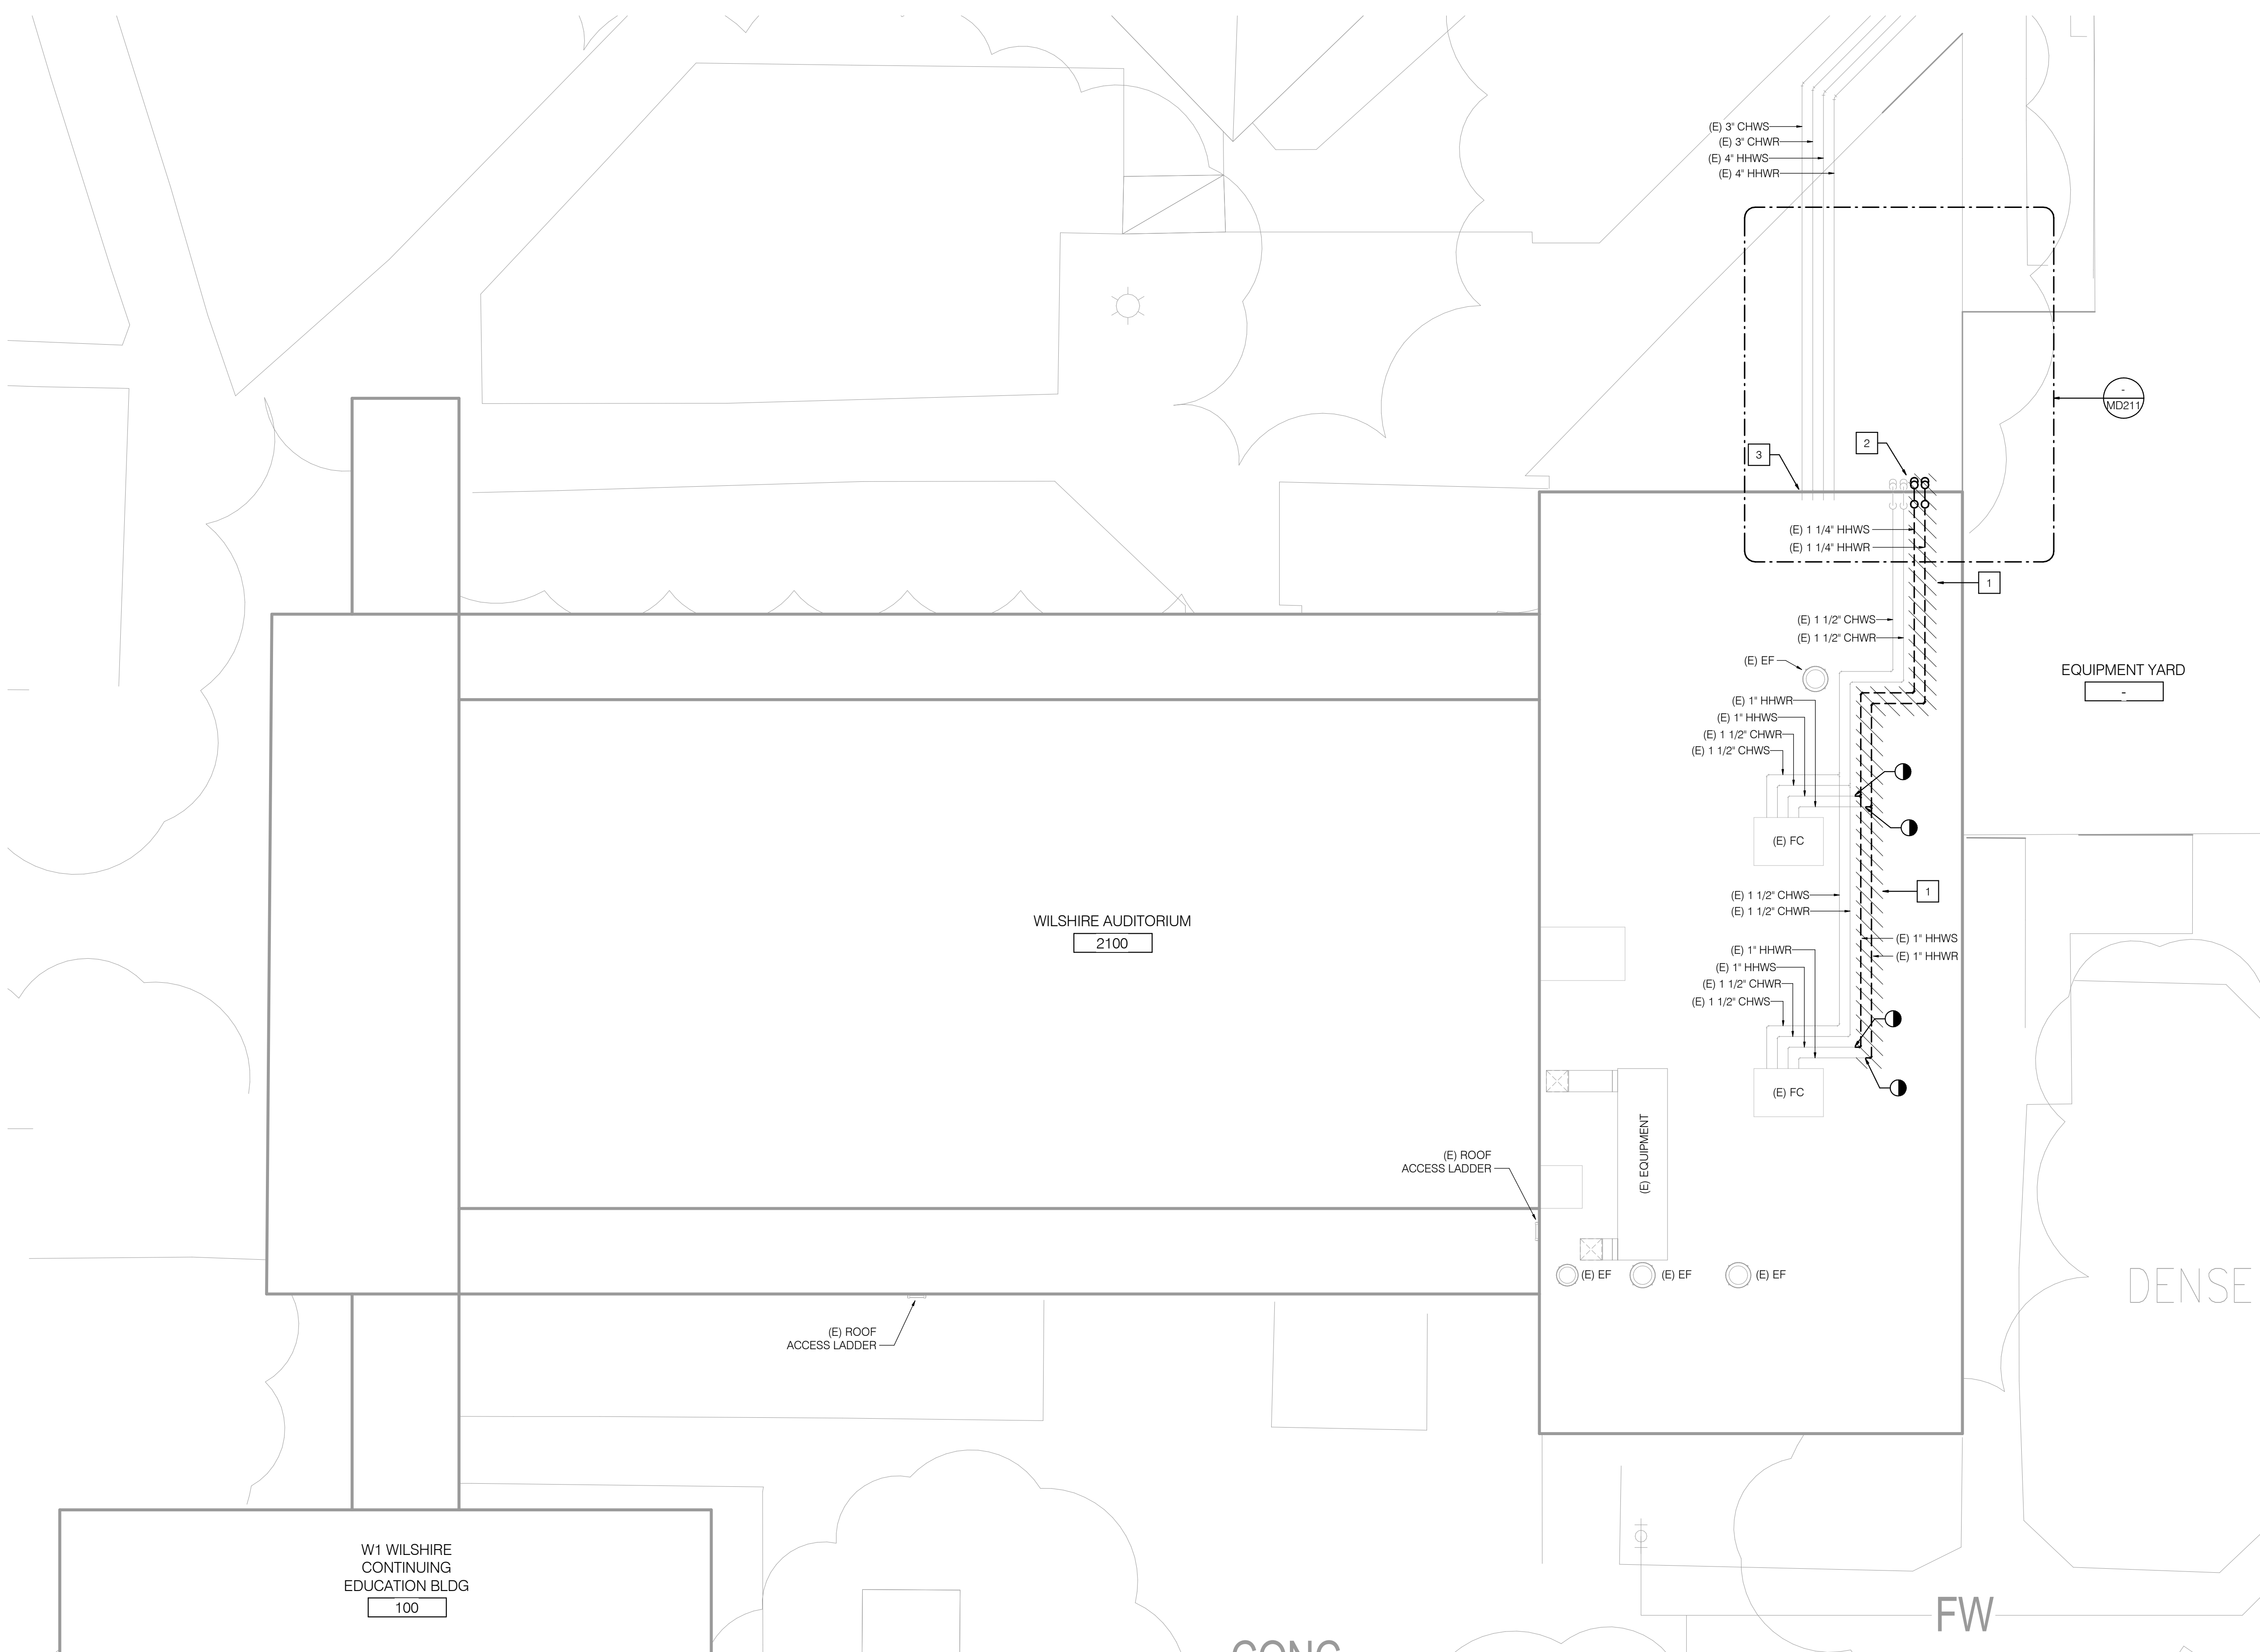

KEY PLAN

LEGEND

 AREA OF WORK



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GENERAL NOTES
1. NO DEMOLITION SHALL BEGIN UNTIL PLANS INCLUDING THE DEMOLITION WORK HAVE BEEN APPROVED BY THE DIVISION OF THE STATE ARCHITECT.

NOTES
1. DEMOLISH ADEQUATE PIPING TO PROVIDE CUT IN FOR 2 INCH TEE AND TWO REDUCERS. SEE M203. ALL SURROUNDING PIPING, EQUIPMENT, AND ANCILLARY DEVICES SHALL BE PROTECTED IN PLACE.
2. DEMOLISH ADEQUATE PIPING TO ALLOW FOR INSTALLATION OF 1-1/2 INCH BALL VALVES FOR ISOLATION. ALL SURROUNDING PIPING, EQUIPMENT, AND ANCILLARY DEVICES SHALL BE PROTECTED IN PLACE.

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Project Title

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321 East Chapman Avenue
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Drawn T Mueller
Checked C Dean
Approved M Phillips

Date January 8, 2020

Submittal DSA Back Check


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Sheet Title
Enlarged Site Plan
Demolition


Sheet Number

MD203

P2S No. 9570

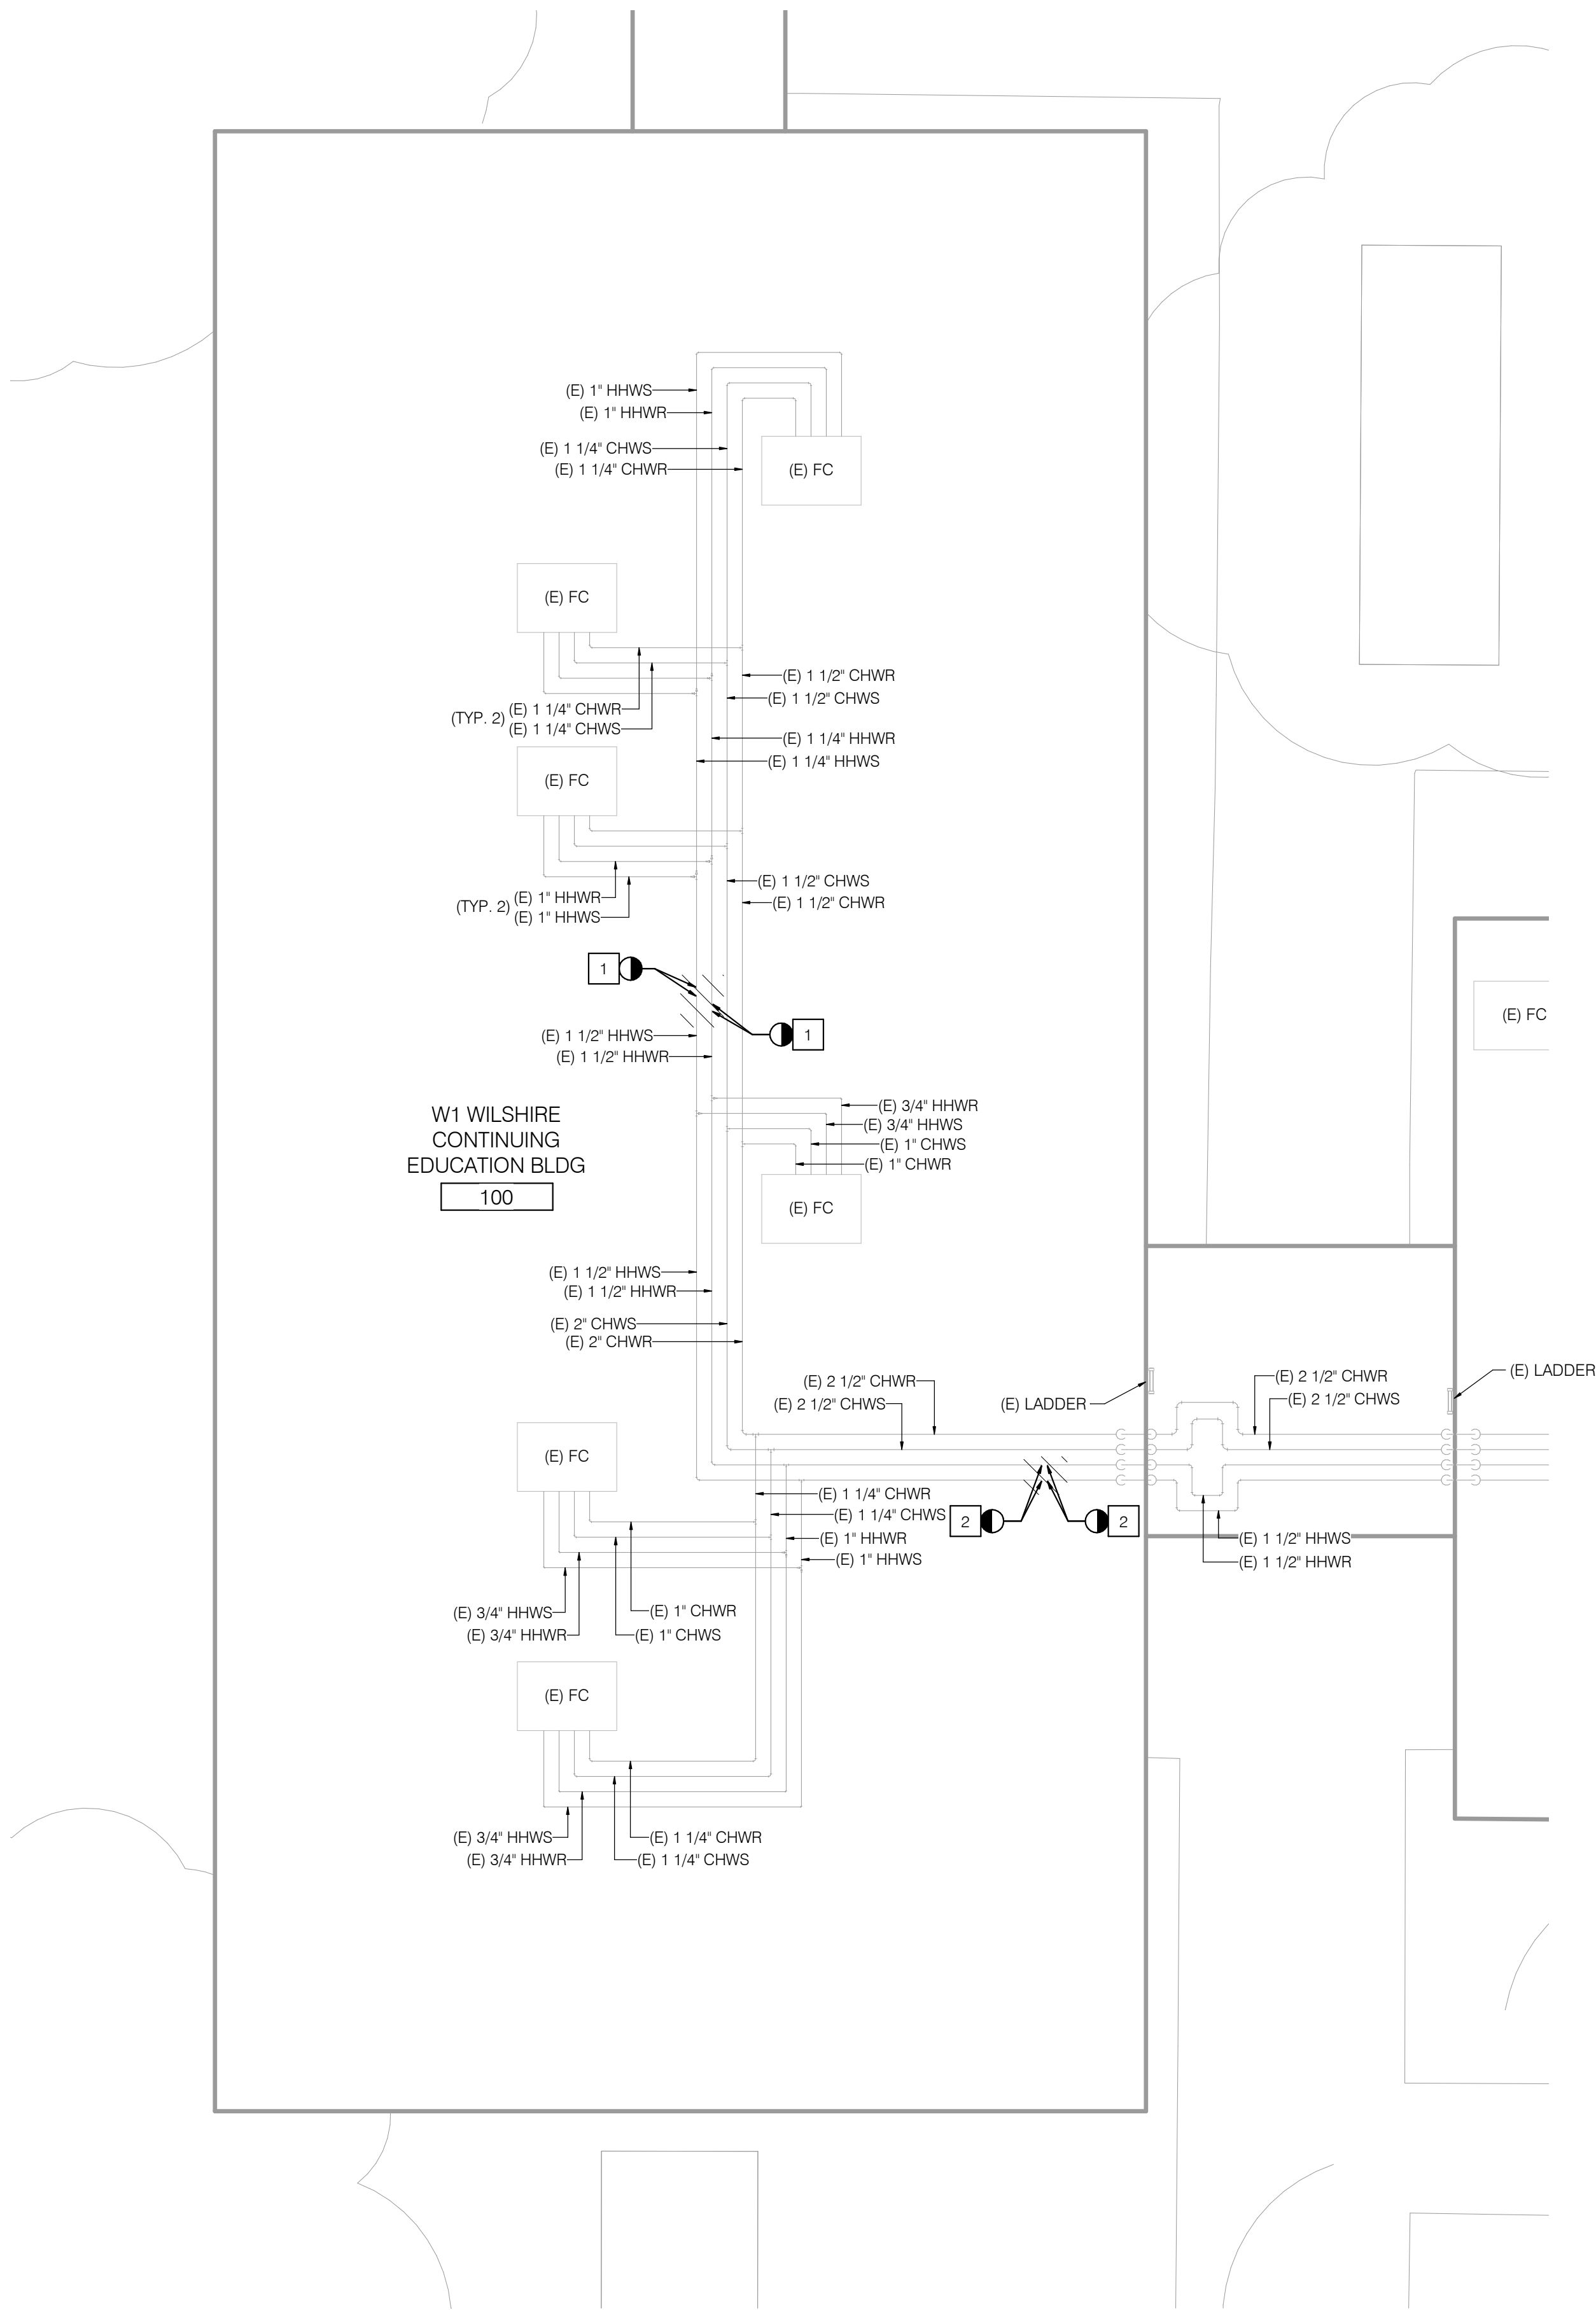

KEY PLAN

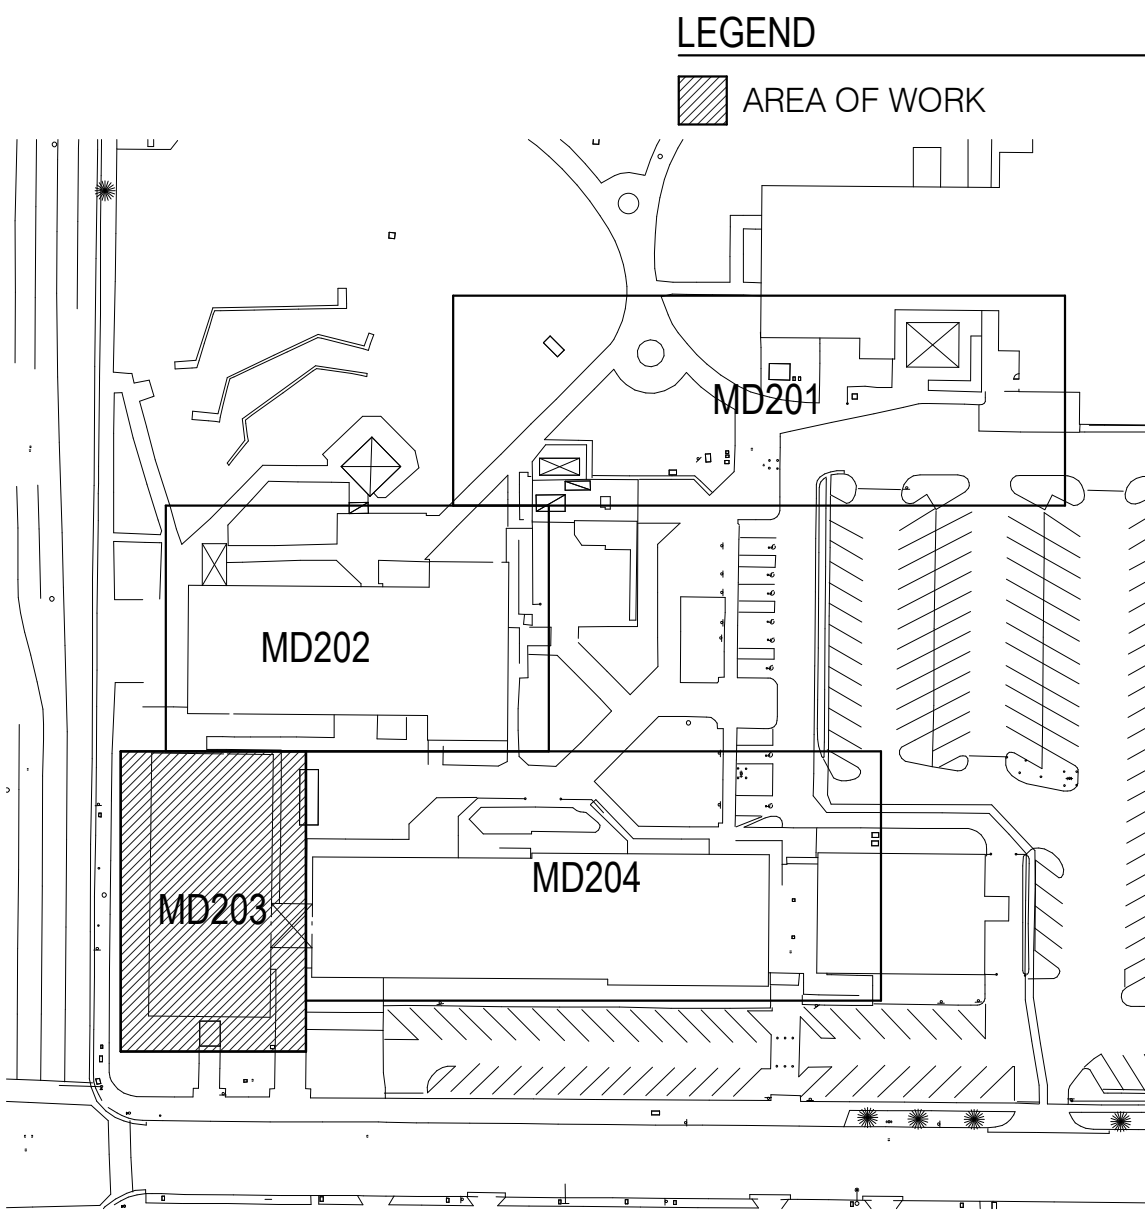

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GENERAL NOTES
1. NO DEMOLITION SHALL BEGIN UNTIL PLANS INCLUDING THE DEMOLITION WORK HAVE BEEN APPROVED BY THE DIVISION OF THE STATE ARCHITECT.

NOTES
1 DEMOLISH ADEQUATE PIPING TO PROVIDE CUT IN FOR 2 INCH TEE. SEE M204.
2 DEMOLISH EXISTING HHWS/R PIPES AS INDICATED. REMOVE CONCRETE SIDEWALK AS NECESSARY. SEE SOUTH PAVING PLAN M302 FOR ADDITIONAL INFORMATION.

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DATE: 01.09.20

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Project Title
**Heating Hot Water
Replacement Parking Lot 10**

Owner



321 East Chapman Avenue
Fullerton, CA 92832



Revisions Number	Description	Date
1	DSA Submittal	10/29/2019
2	DSA Back Check	1/8/2020

Designed T Mueller
Drawn T Mueller
Checked C Dean
Approved M Phillips

Date January 8, 2020

Submittal DSA Back Check


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Sheet Title
**Enlarged Site Plan
Demolition**


Sheet Number

MD204

P2S No. 9570

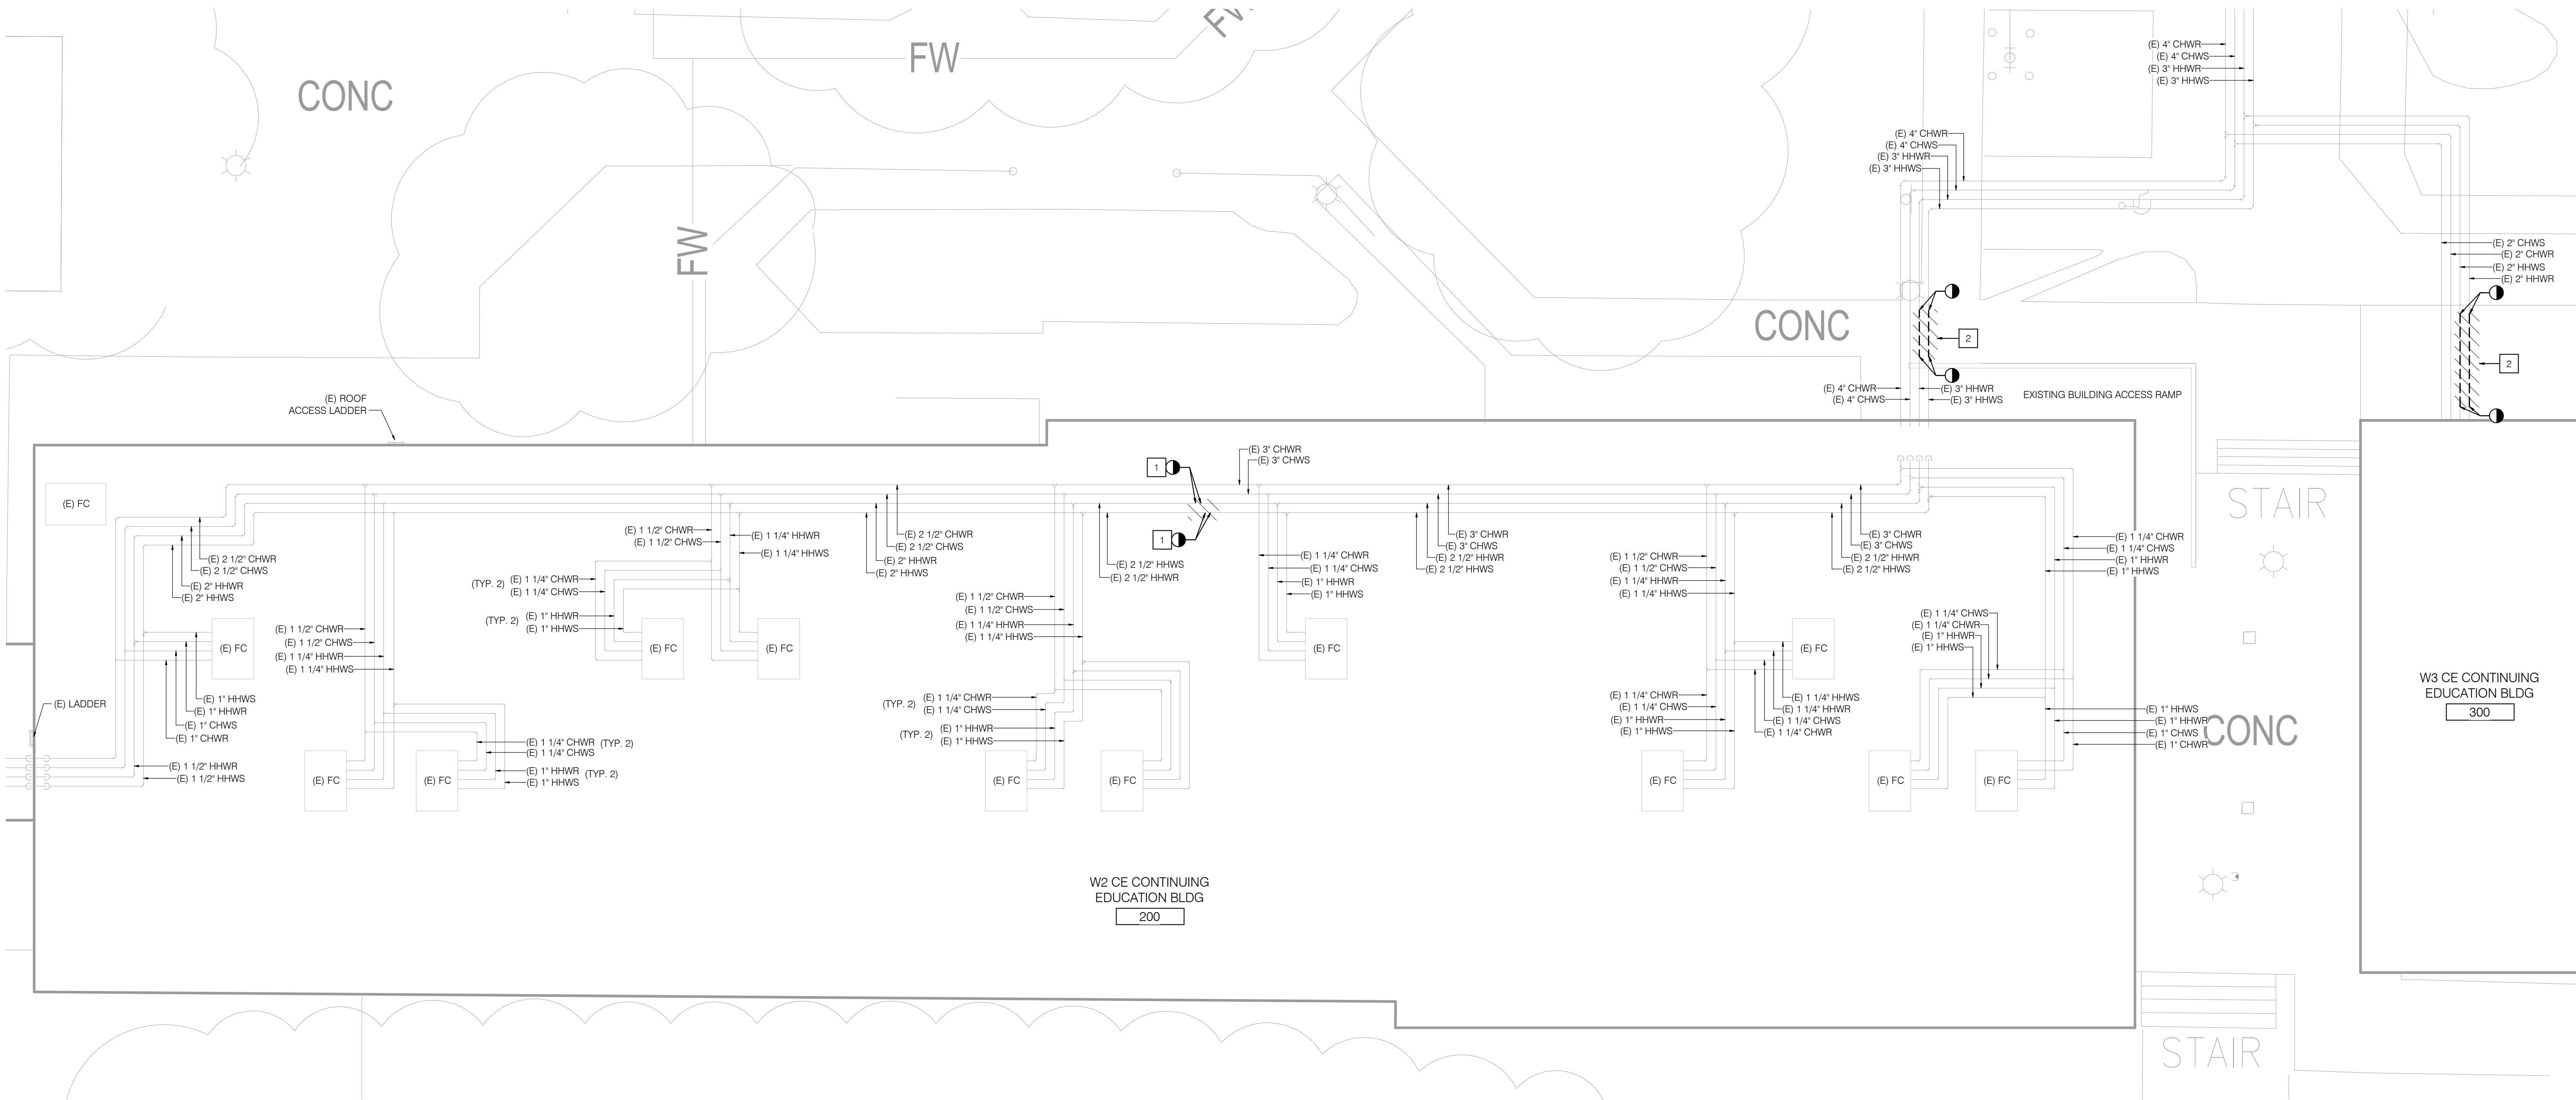

KEY PLAN

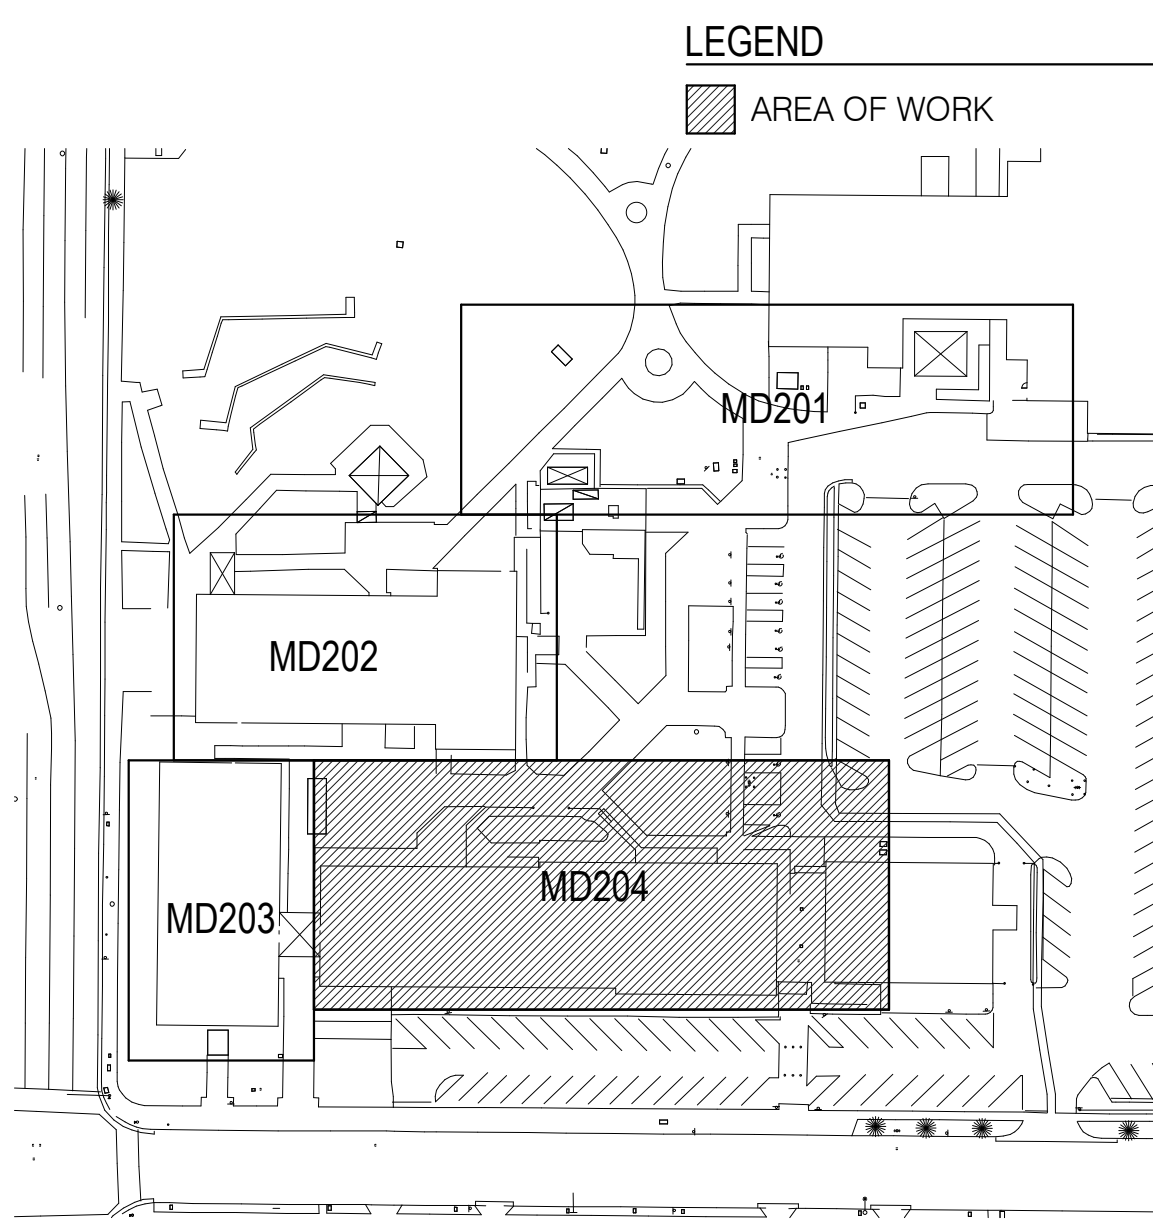

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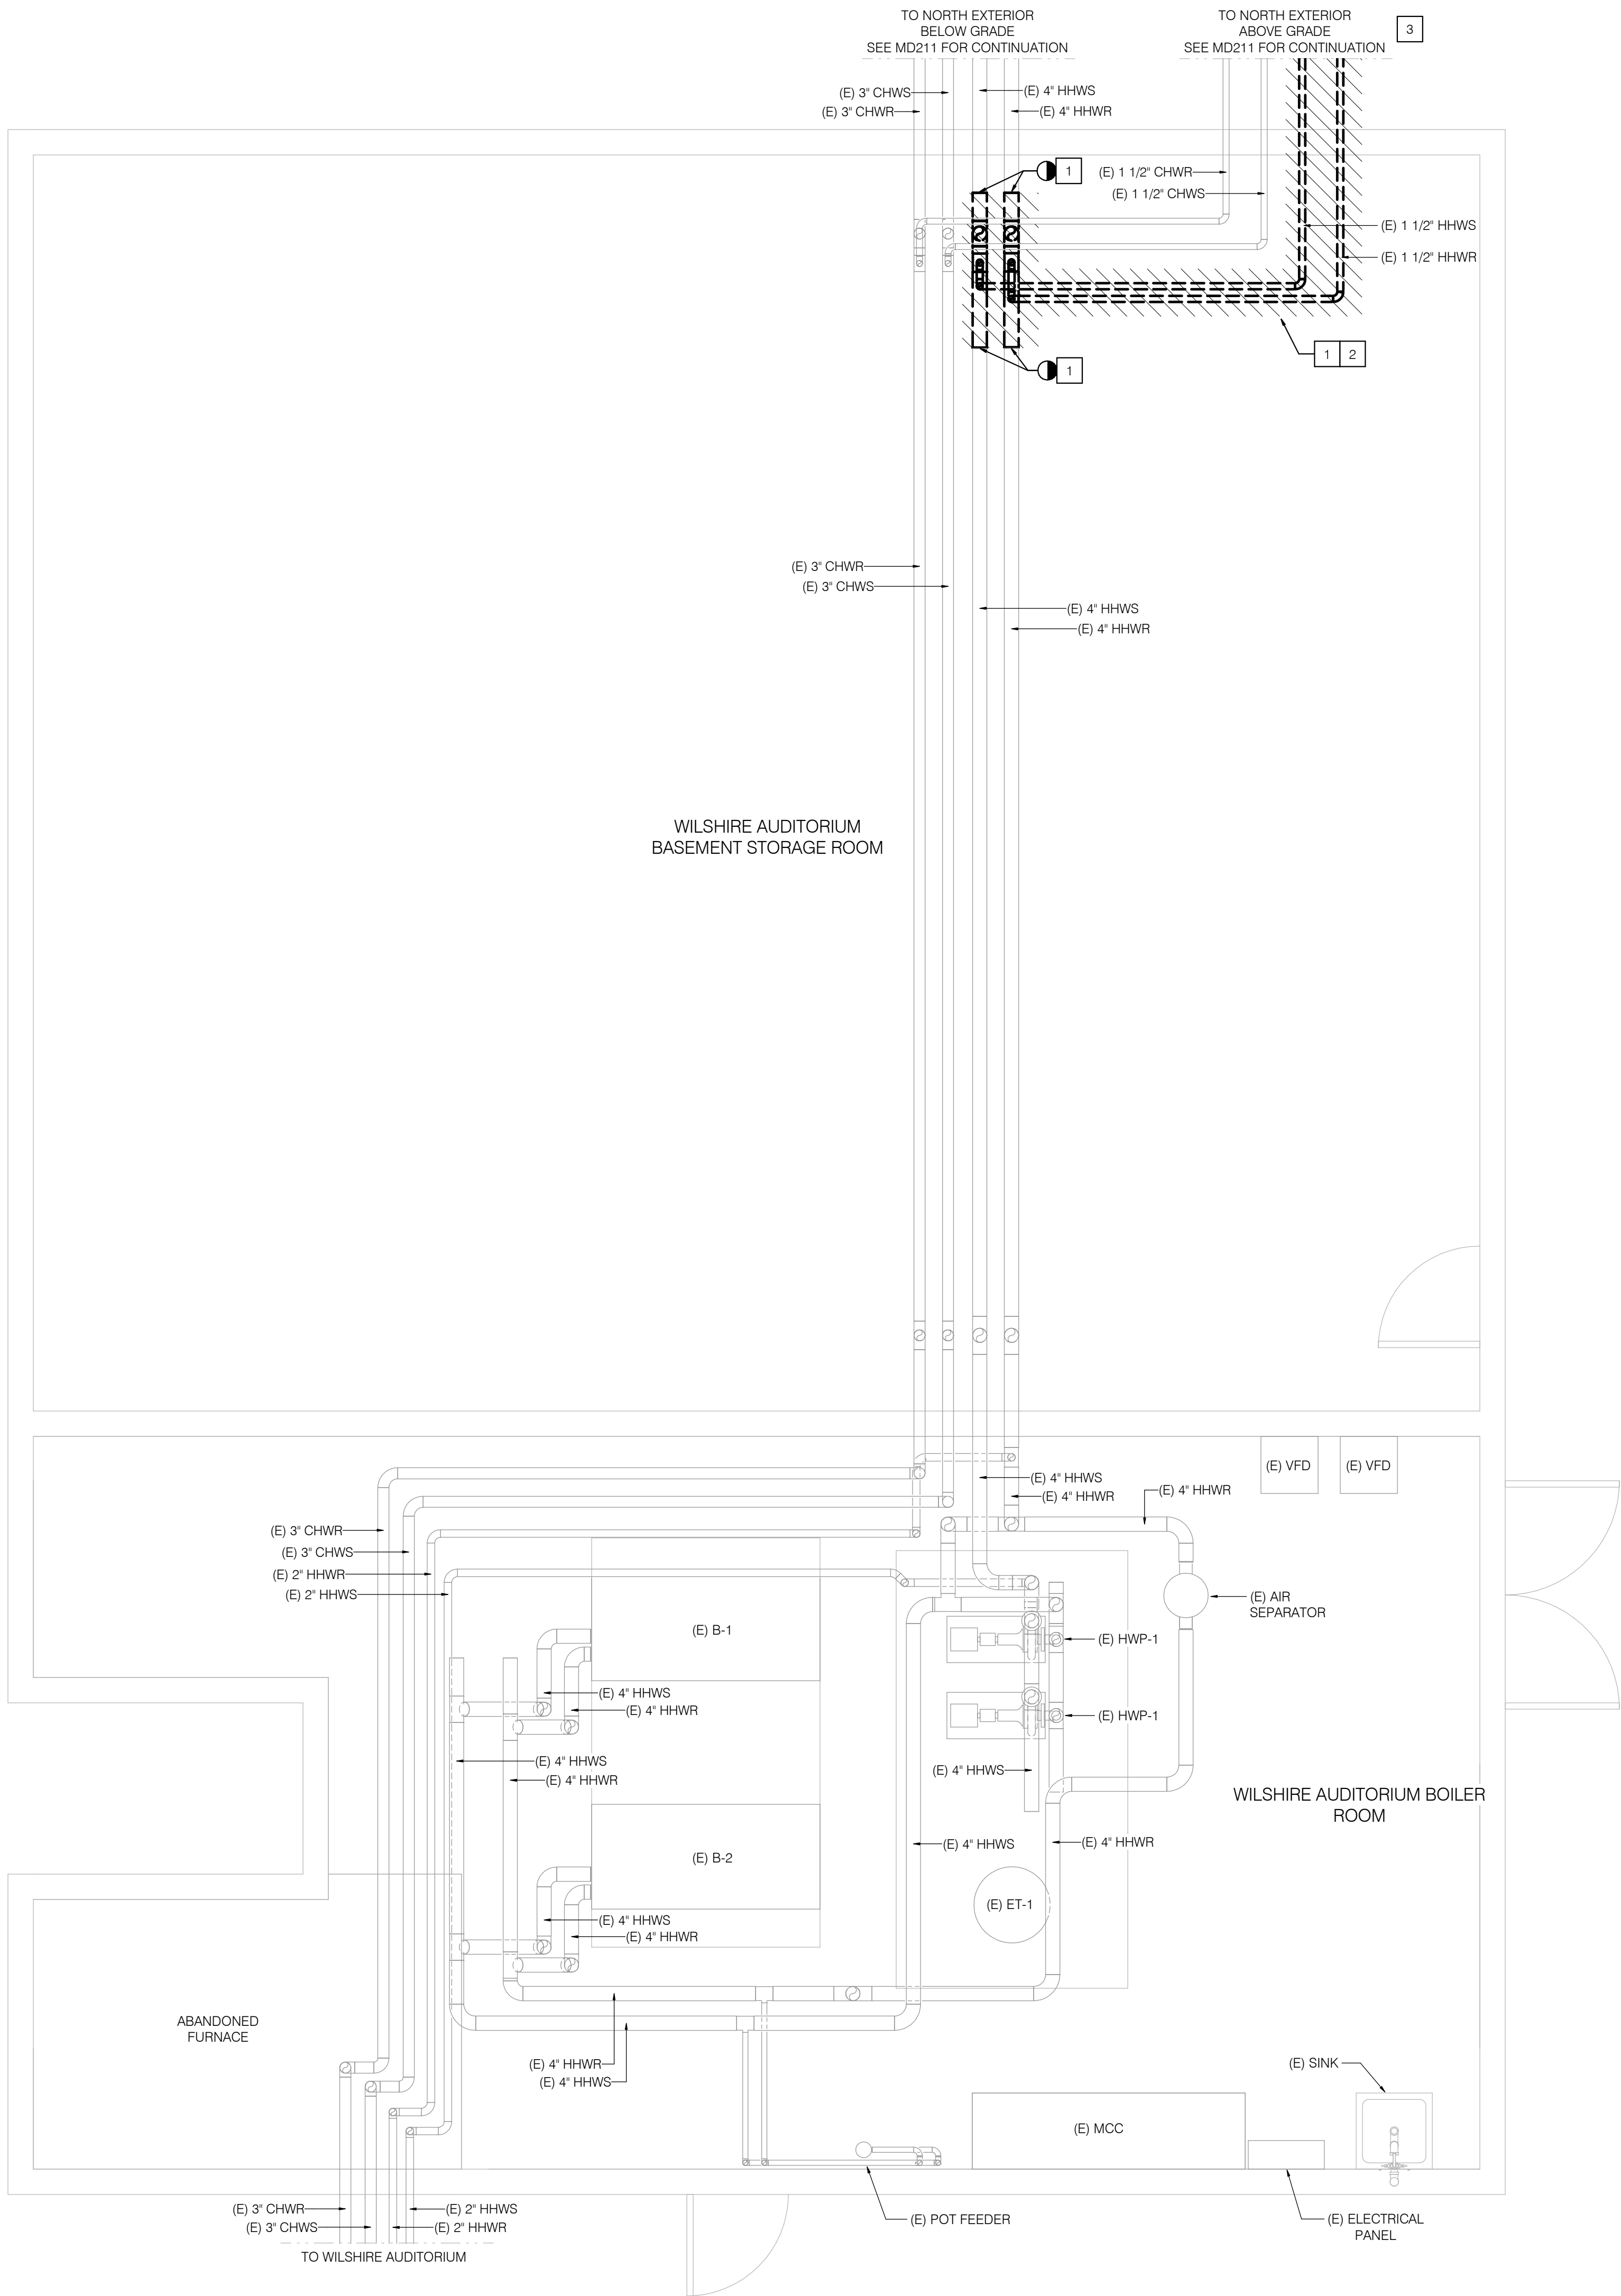
A

B

C

D

E





GENERAL NOTES

1. NO DEMOLITION SHALL BEGIN UNTIL PLANS INCLUDING THE DEMOLITION WORK HAVE BEEN APPROVED BY THE DIVISION OF THE STATE ARCHITECT.

NOTES

- 1 DEMOLISH EXISTING HHWS/R PIPES AS INDICATED. ALL CHW PIPING IS TO REMAIN AND SHALL BE PROTECTED IN PLACE.
- 2 DEMOLISH EXISTING PIPE SUPPORTS. EXISTING PIPE SUPPORTS ALSO SUPPORT REMAINING (E)CHWS/R PIPES. DO NOT REMOVE EXISTING SUPPORTS UNTIL REPLACEMENT SUPPORTS HAVE BEEN INSTALLED.
- 3 DEMOLITION OF HHWS/R PIPING CONTINUES ON NORTH EXTERIOR OF WILSHIRE AUDITORIUM. SEE SHEET MD211 FOR CONTINUATION OF DEMOLITION.

KEY PLAN

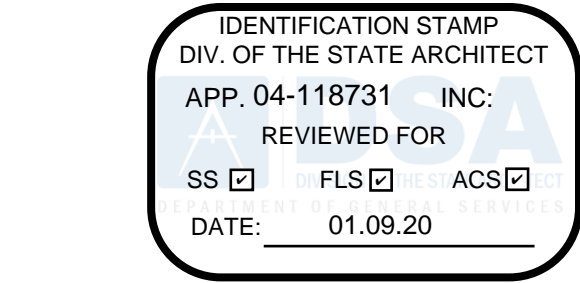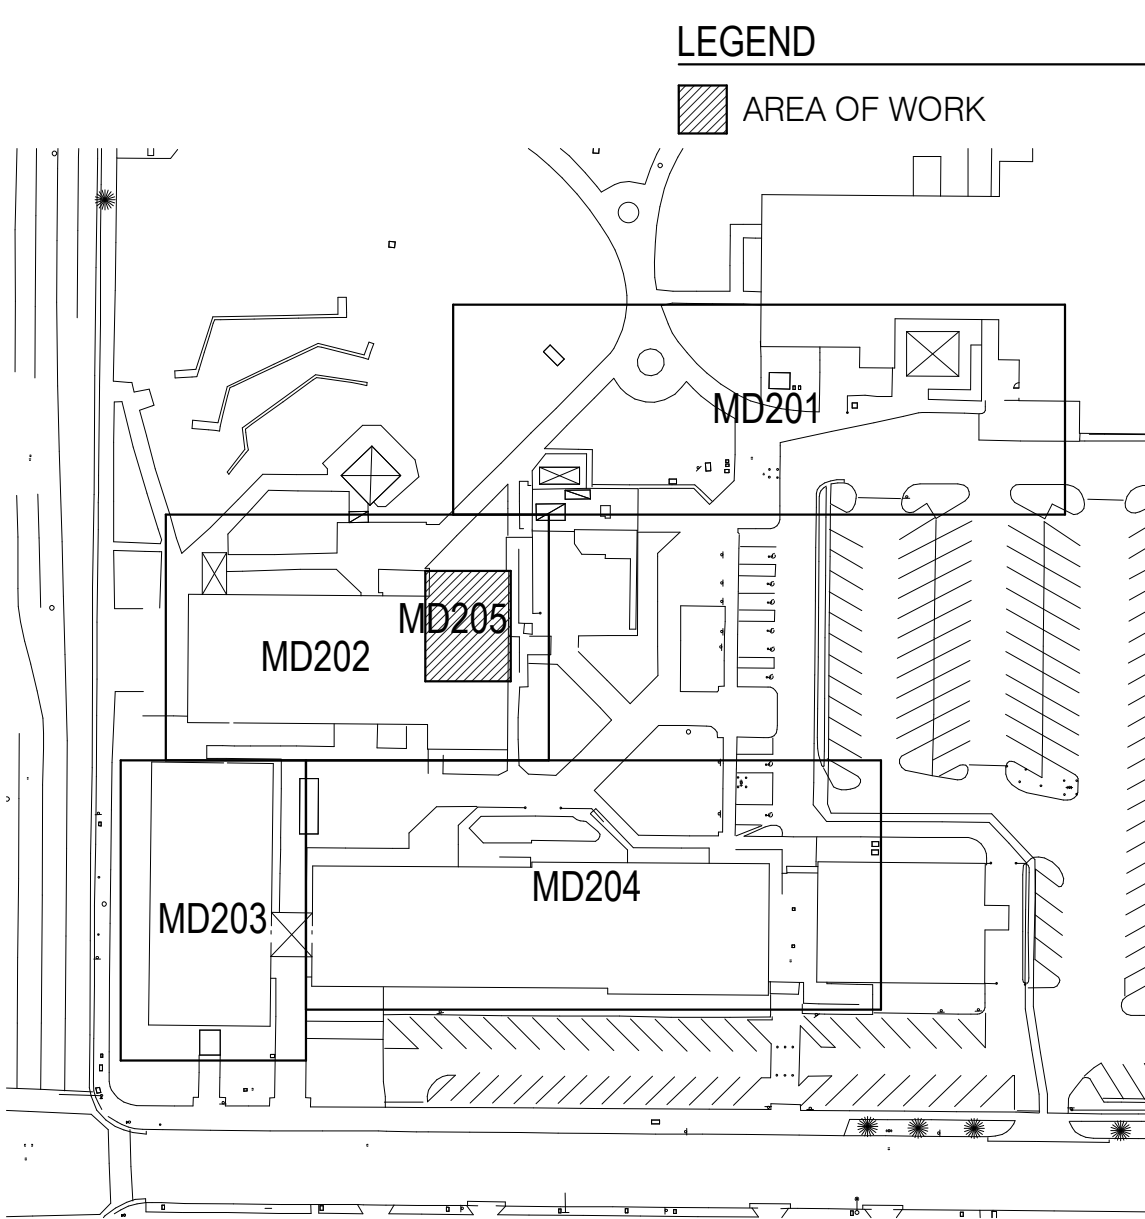

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Project Title
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Fullerton, CA 92832



Revisions		
Number	Description	Date
	DSA Submittal	10/29/2019
	DSA Back Check	1/8/2020

Designed T Mueller
Drawn T Mueller
Checked C Dean
Approved M Phillips

Date January 8, 2020

Submittal DSA Back Check

Scale 3/8" = 1'-0"

Sheet Title
Building 2100 - Basement
Demolition

Sheet Number
MD205

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A


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C


D

E


3 BUILDING 2100 DEMOLITION - NORTH SECTION
SCALE: 1/2" = 1'-0"

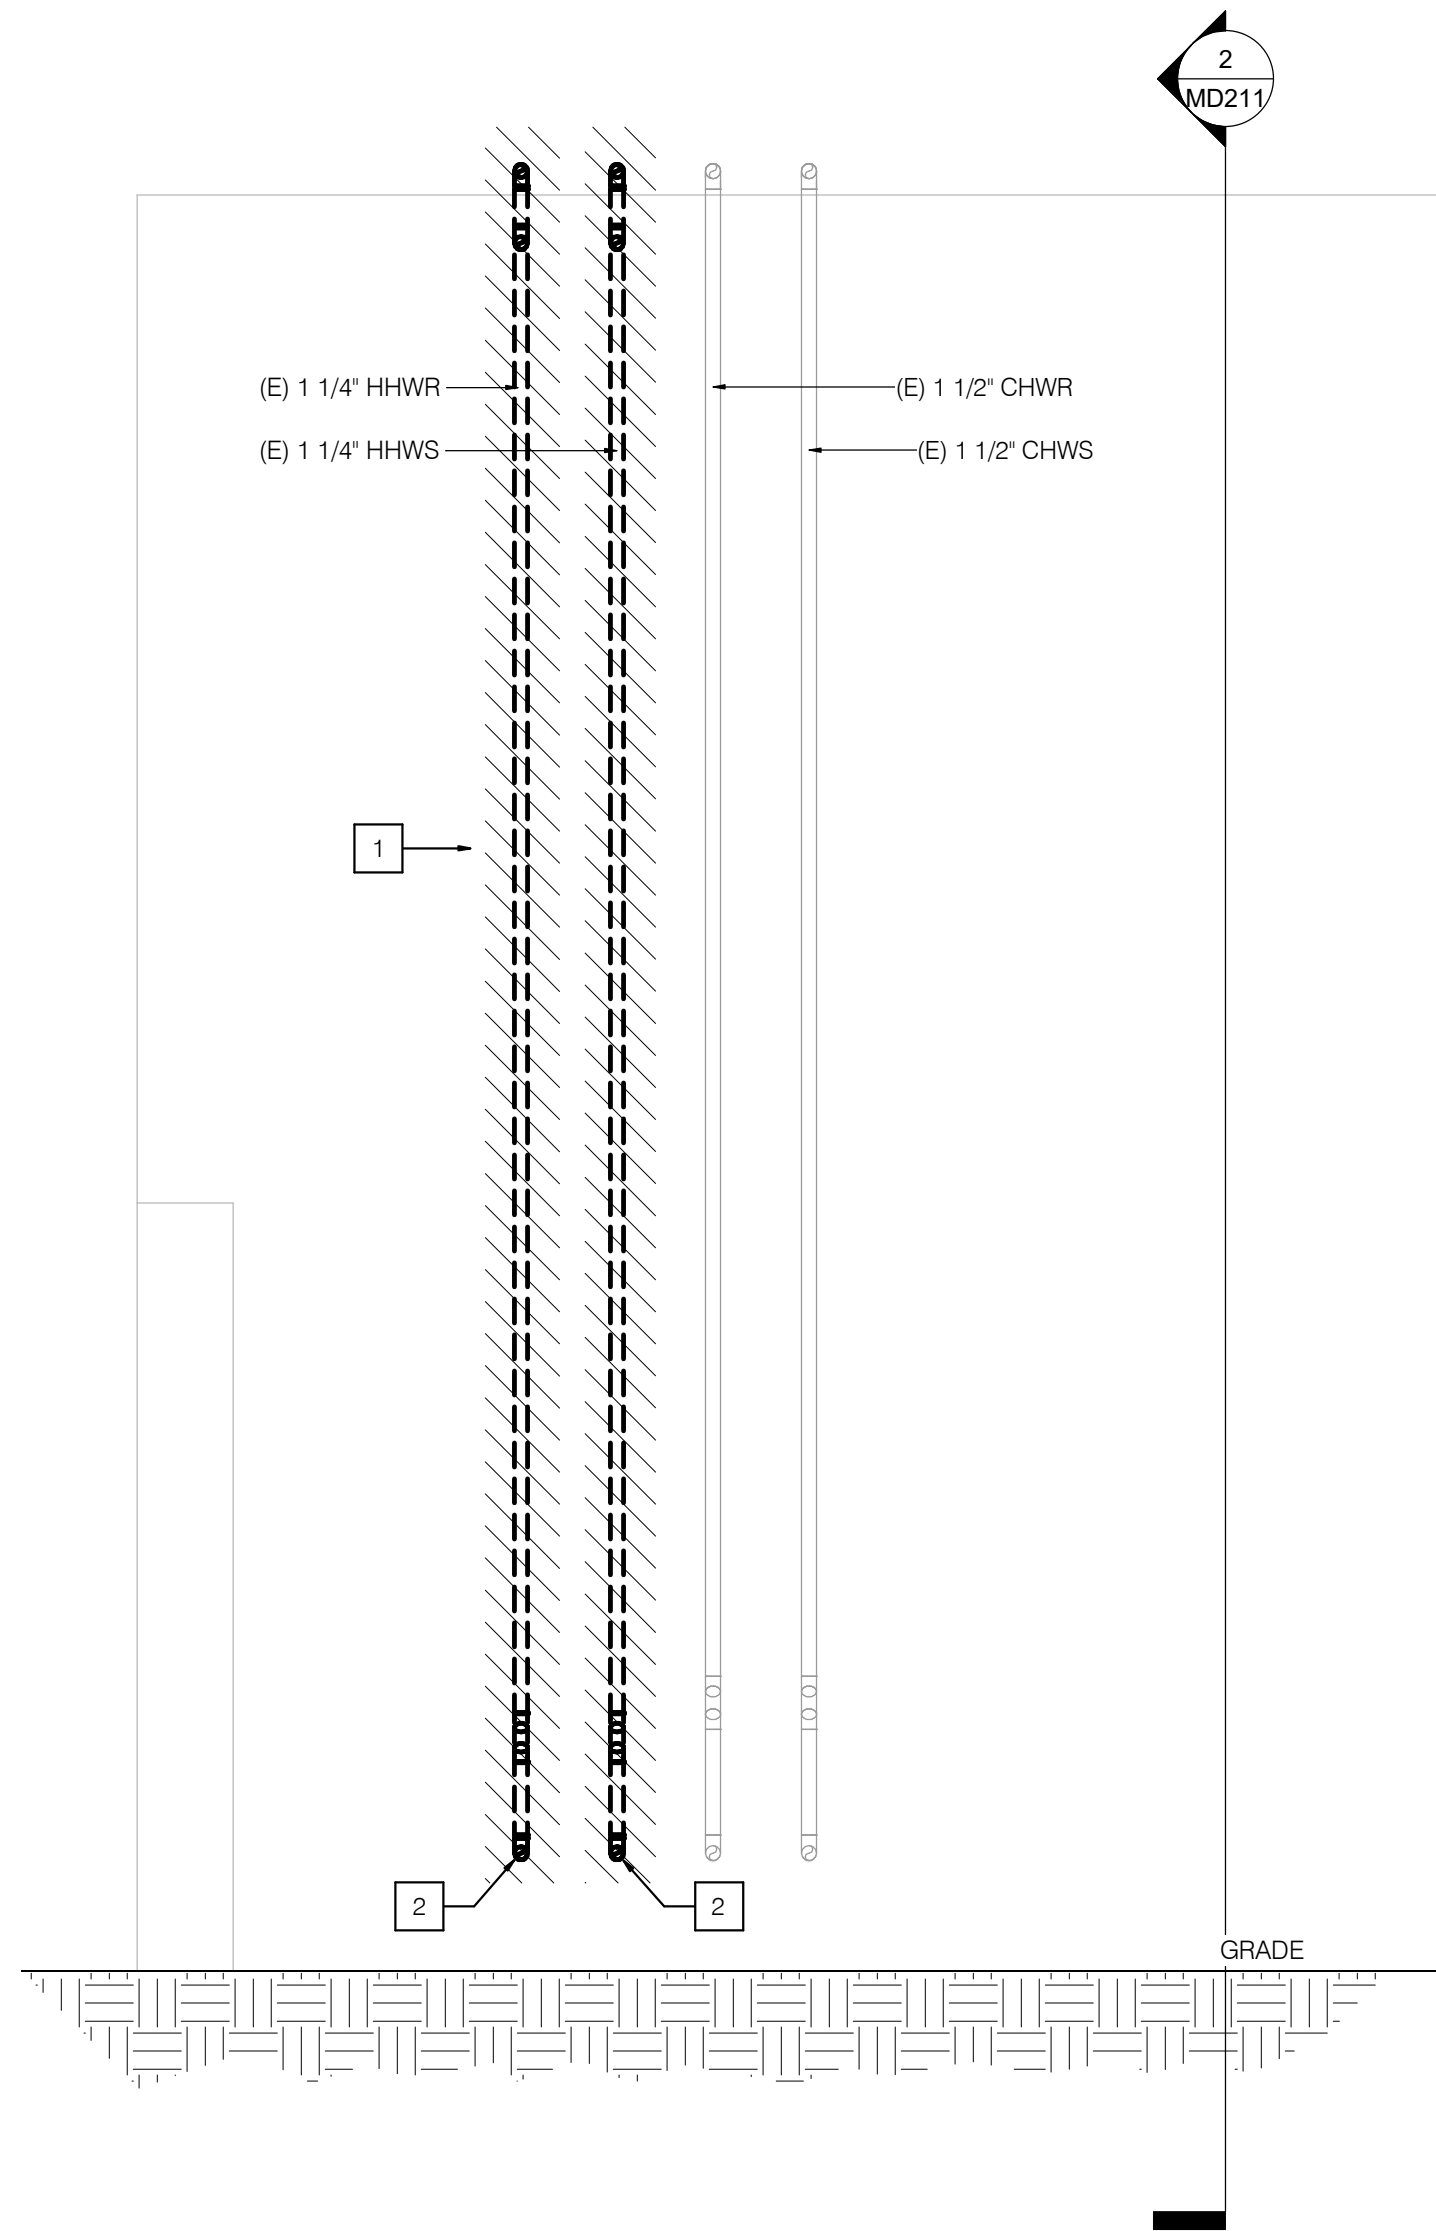

1 BUILDING 2100 DEMOLITION PLAN
SCALE: 1/4" = 1'-0"

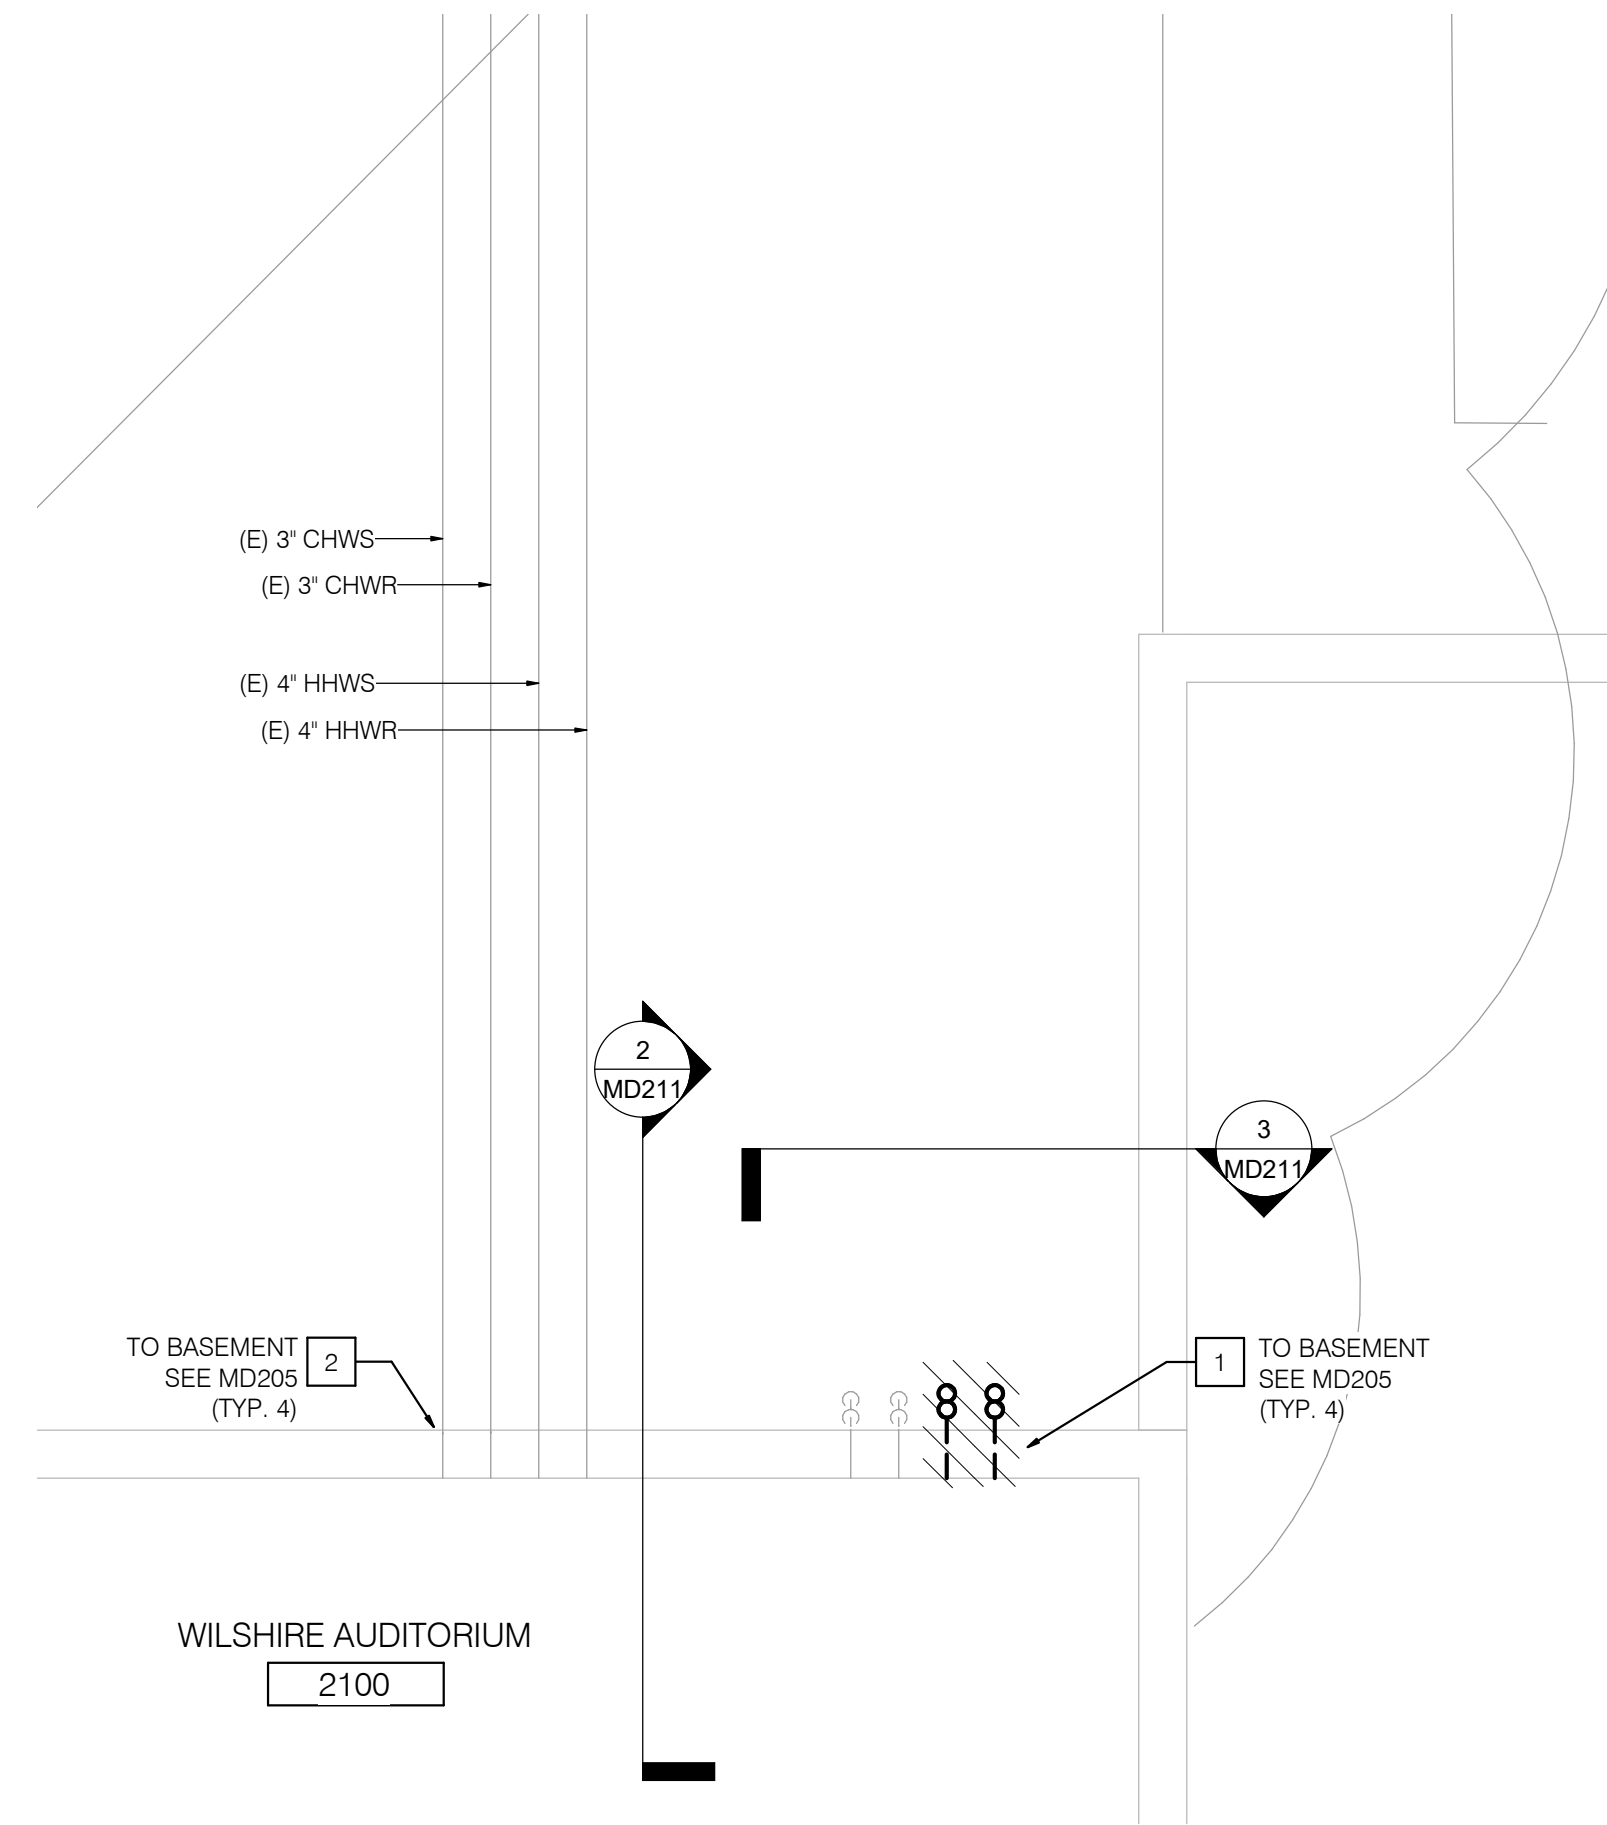

2 BUILDING 2100 DEMOLITION - WEST SECTION
SCALE: 1/2" = 1'-0"

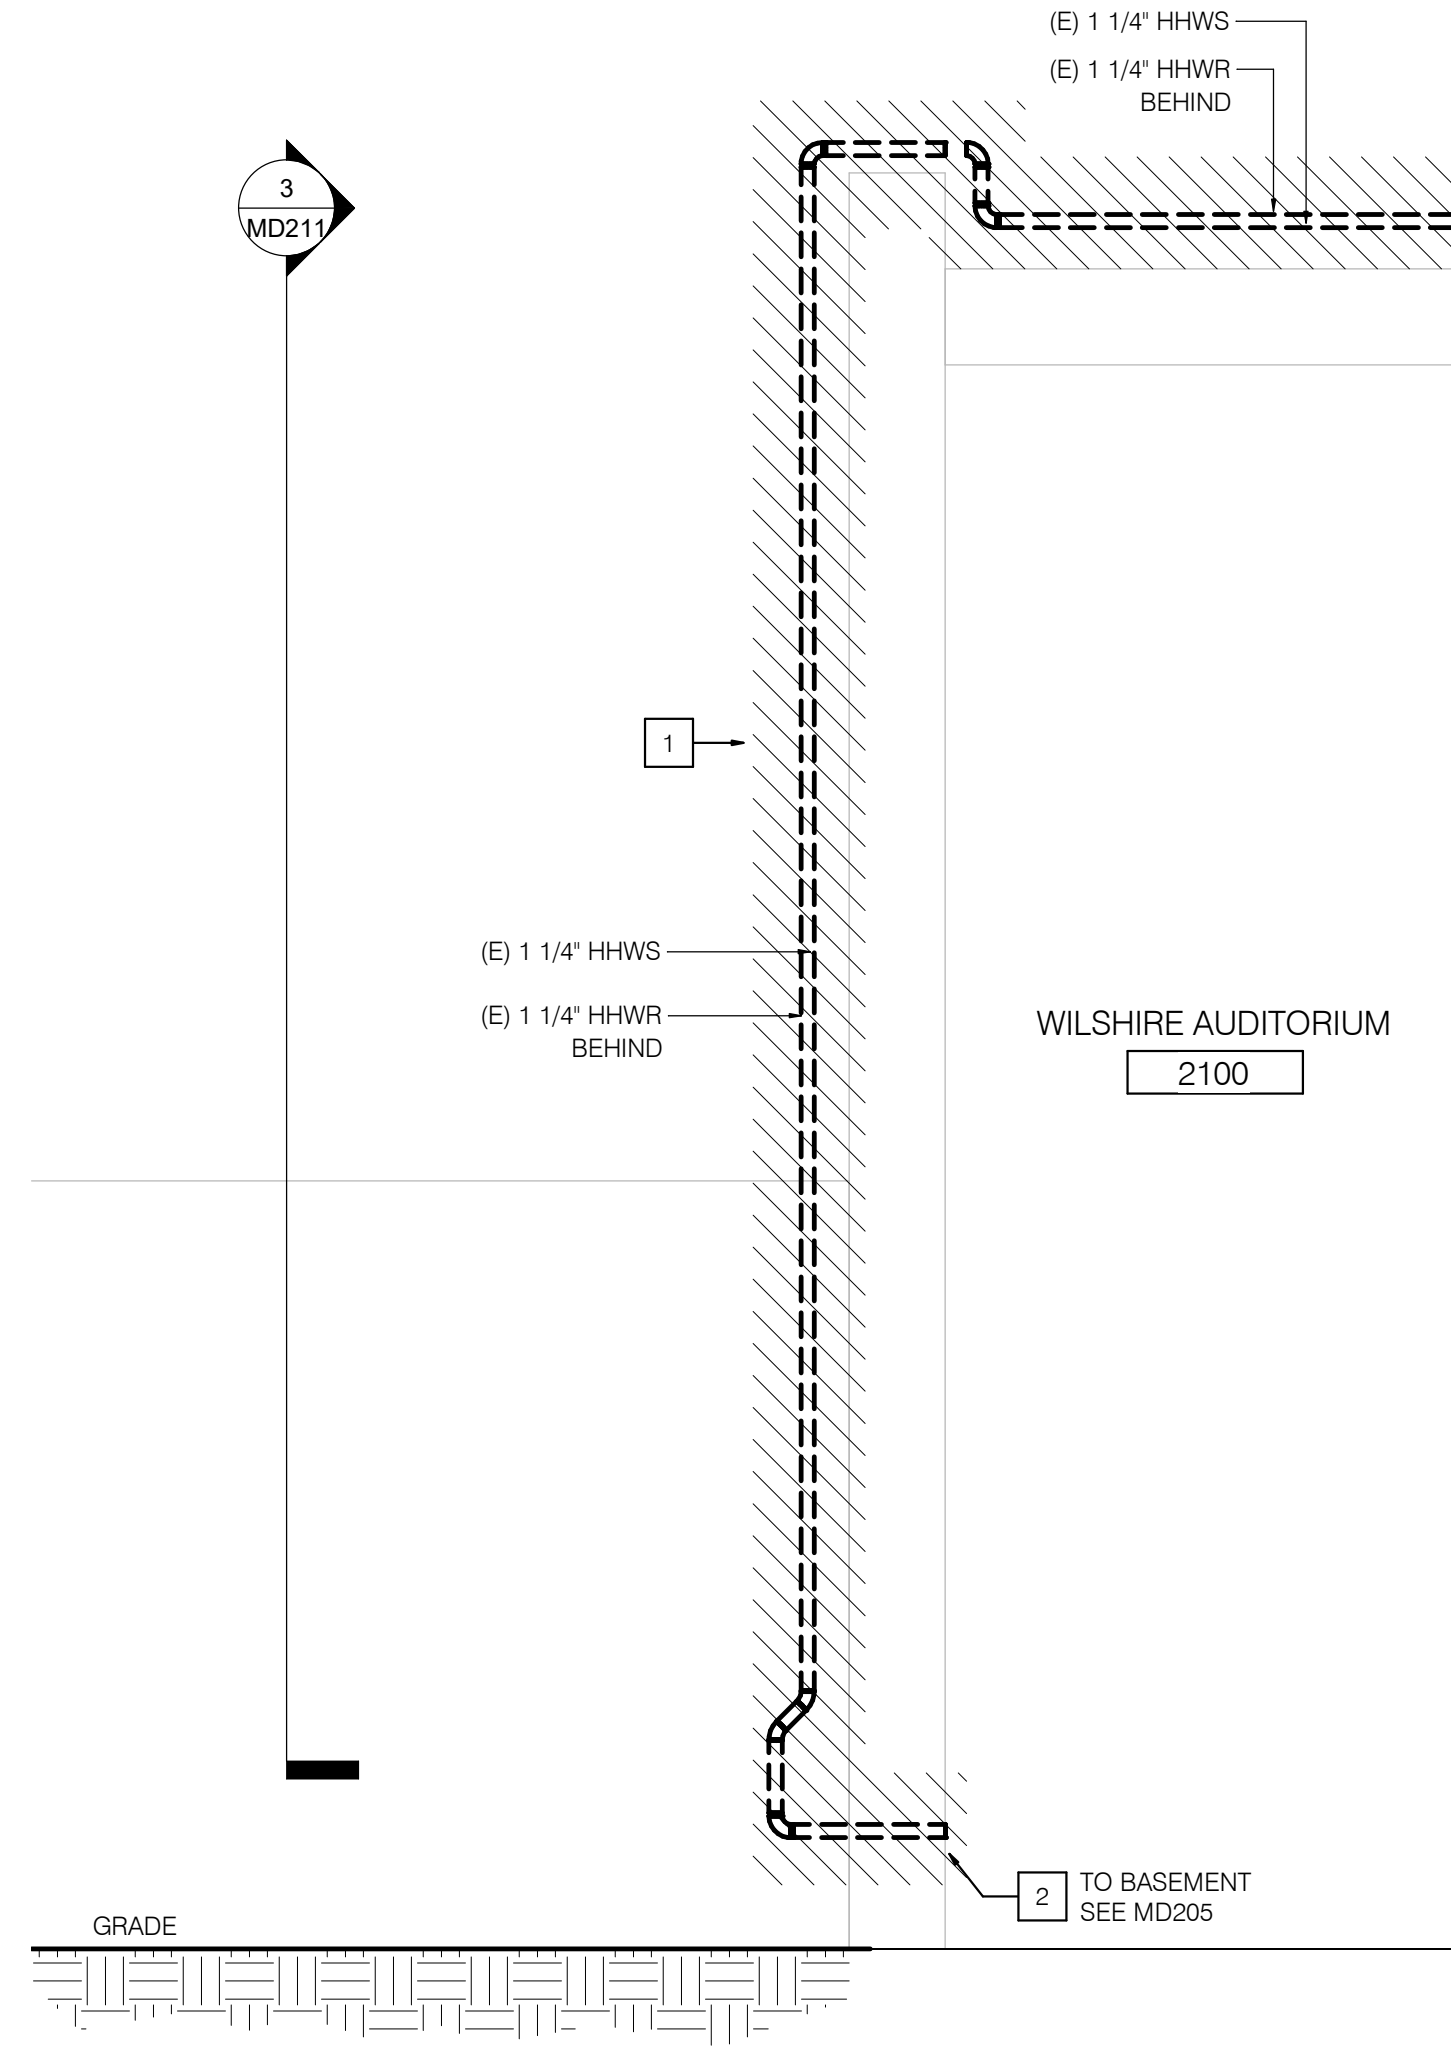


GENERAL NOTES

1. NO DEMOLITION SHALL BEGIN UNTIL PLANS INCLUDING THE DEMOLITION WORK HAVE BEEN APPROVED BY THE DIVISION OF THE STATE ARCHITECT.

NOTES

- 1 DEMOLISH EXISTING HHWS/R PIPES AND ATTACHED PIPING ACCESSORIES AND SUPPORTS AS INDICATED. ALL OTHER SURROUNDING PIPING, EQUIPMENT, AND ANCILLARY DEVICES SHALL BE PROTECTED IN PLACE. FOR CONTINUATION, SEE MD205.
- 2 EXISTING PIPES PENETRATE EXTERIOR WALL AND CONTINUE INTO WILSHIRE AUDITORIUM BASEMENT STORAGE ROOM. FOR CONTINUATION, SEE MD205.

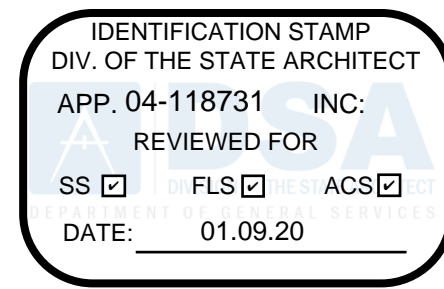

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Designed

T Mueller

Drawn

T Mueller

Checked

C Dean

Approved

M Phillips

Date

January 8, 2020

Submittal

DSA Back Check

Scale

As indicated

Sheet Title

Demolition Plan Building
2100

Sheet Number


MD211

P2S No. 9570



NOTES

1 DEMOLISH EXISTING HHWS/R PIPING AS INDICATED.
EXISTING PIPING IS ENCASED IN REINFORCED CONCRETE.
ADJACENT CHW PIPES SHALL BE PROTECTED IN PLACE.

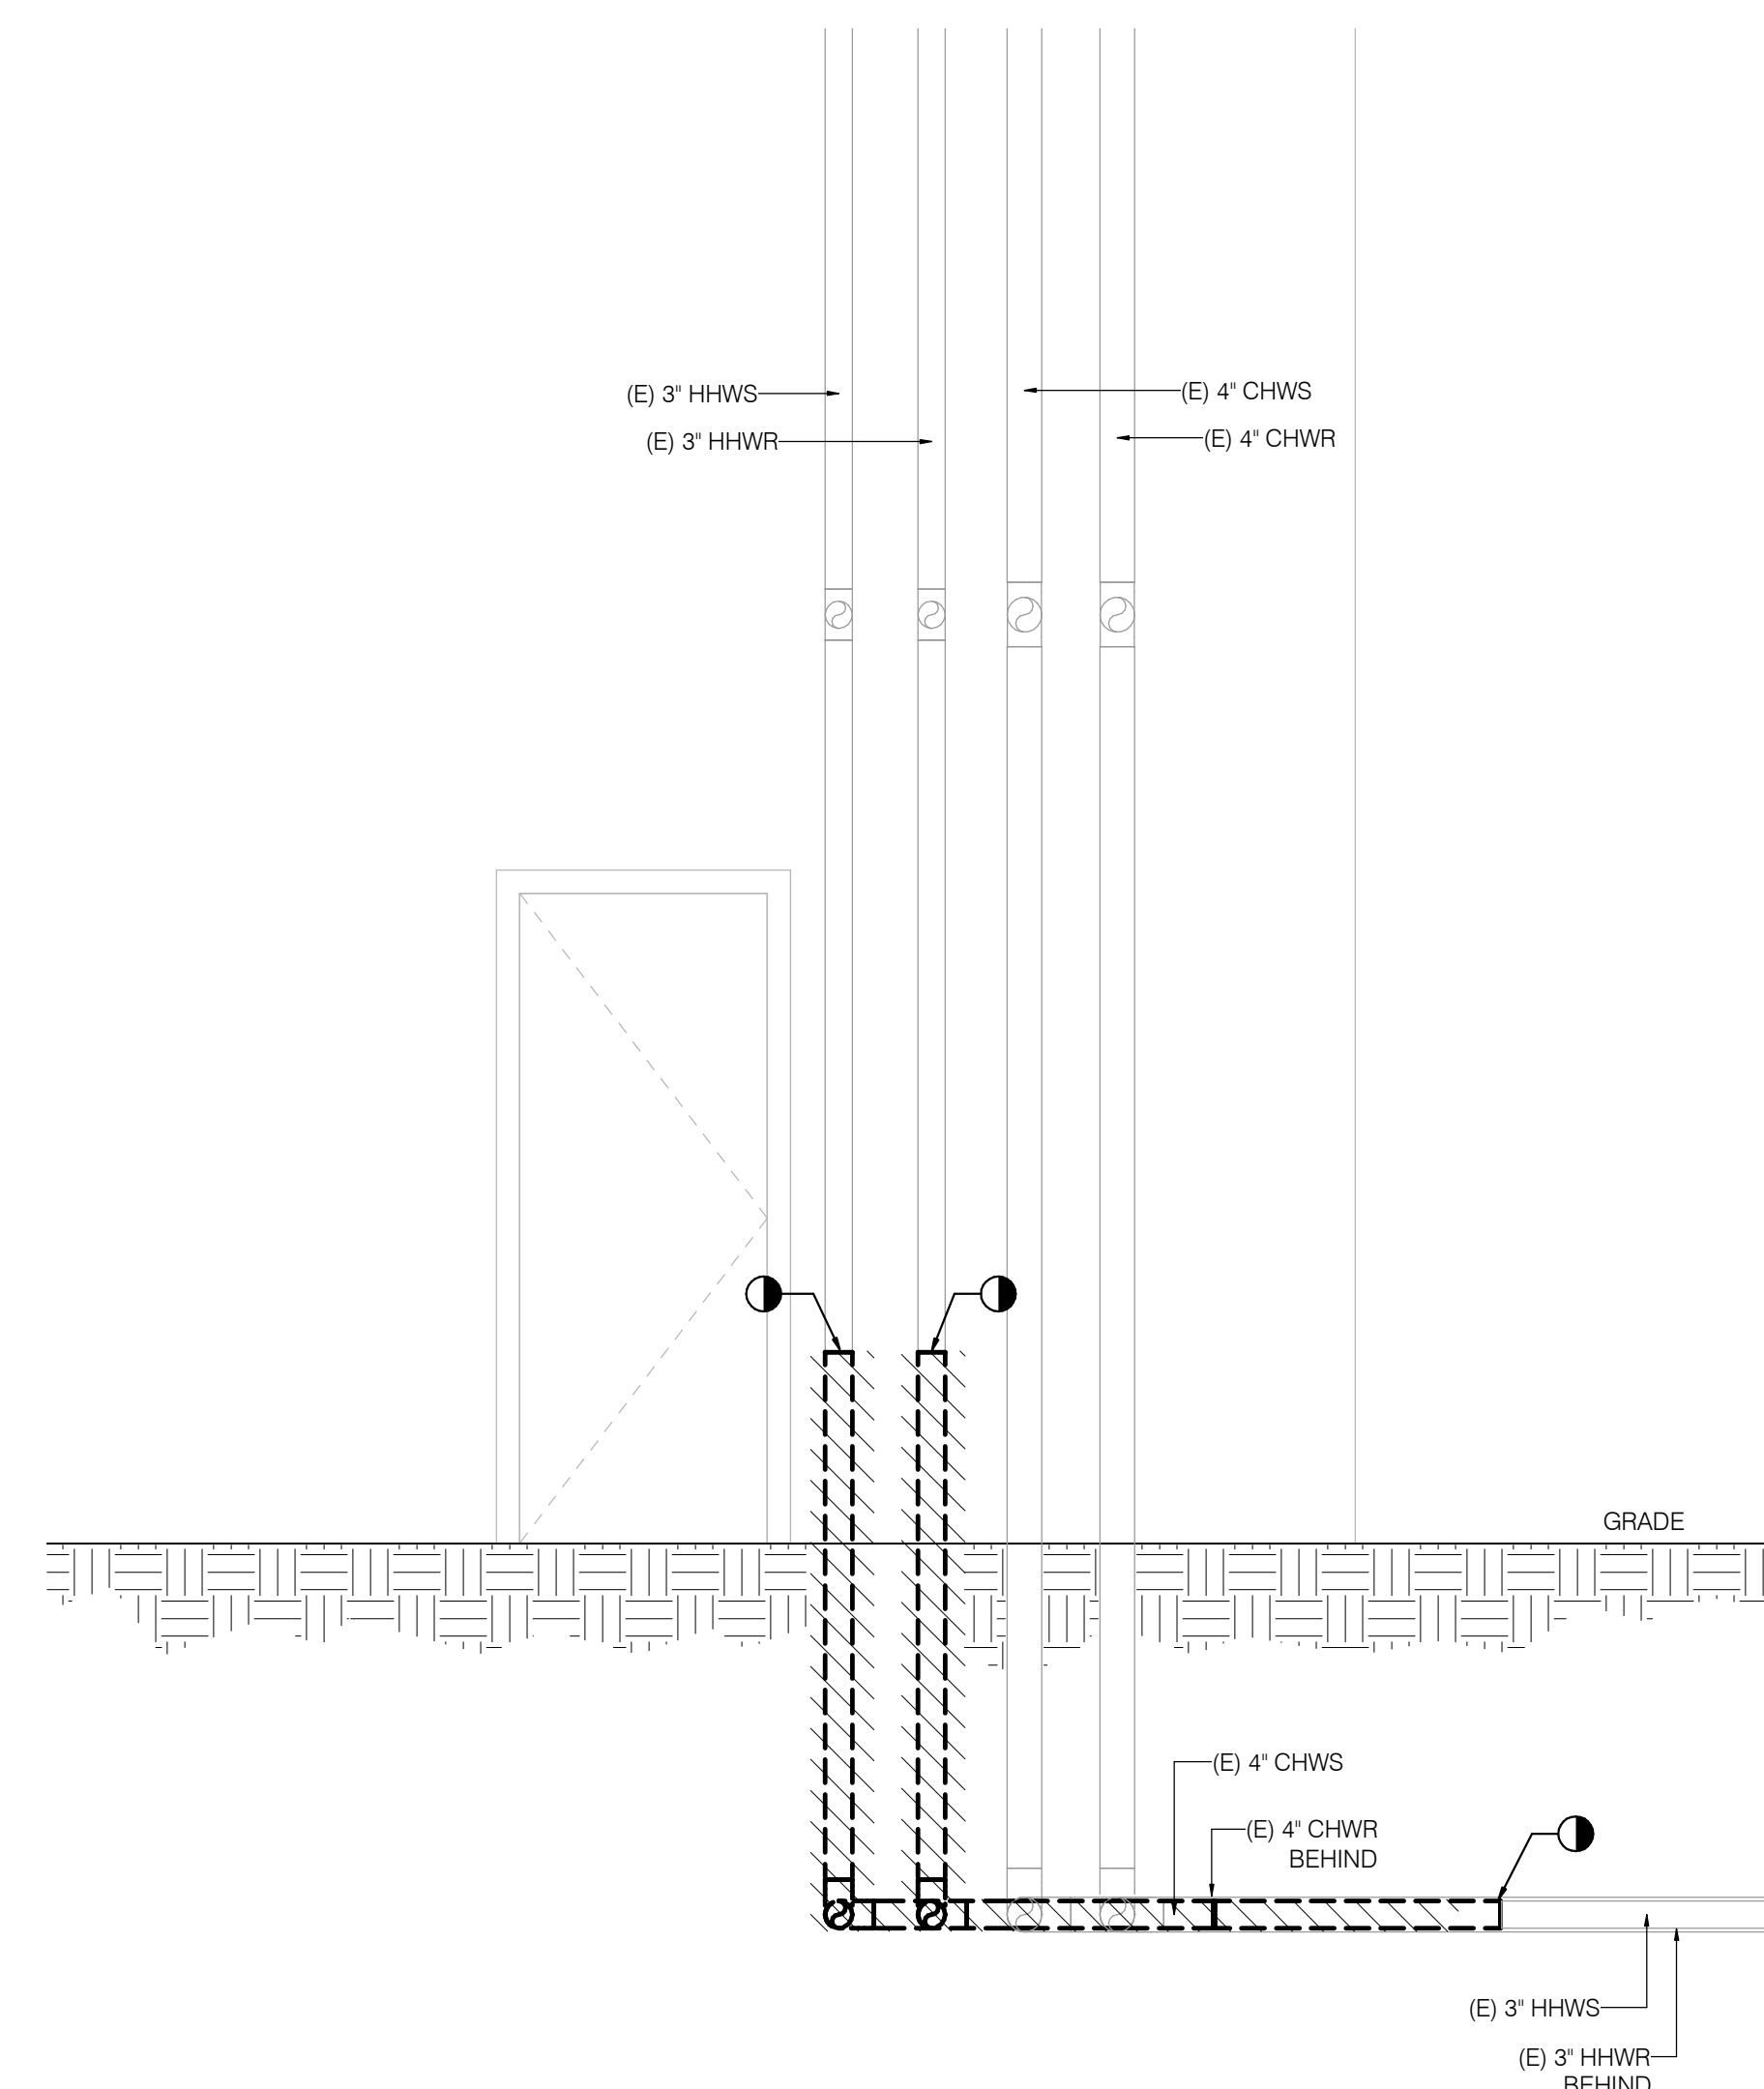

SCALE: 1/2" = 1'-0"